

LONDON BOROUGH OF ENFIELD**PLANNING COMMITTEE****Date: 18th June 2024****Report of**

Karen Page –
Head of Planning & Building
Control

Contact Officers:

Samuel Wong – Case Officer
Sharon Davidson –
Planning Decisions Manager

Category

Major

Ward

Southbury

Councillor Request

No

LOCATION: Enfield District Heat Network Between Southbury Road EN1 Hertford Road And St Martins Road N9

APPLICATION NUMBER: 24/01437/FUL

PROPOSAL: Amendment to Phase 1 of a Borough-wide district heat distribution network in Enfield comprising pipework of approximately 7km in length as approved under application reference 22/00047/FUL, the proposed part of the route comprising a diversion along Rays Road, Montagu Road and Kenninghall Road, and then a further diversion under the North Circular Road (A406) before connecting with the remainder of the approved route near the junction of Leopold Road with Albany Road. Proposed leak detection cabinets to be located along part of the revised route.

Applicant Name & Address:

D3 Associates Limited
c/o DRK Planning Limited
215 Alfred Court
53 Fortune Green Road
London
NW6 1DF

Agent Name & Address:

Mr David Kemp
DRK Planning Ltd
215 Alfred Court
53 Fortune Green Road
West Hampstead
NW6 1DF

RECOMMENDATION:

1. That planning permission be **GRANTED** subject to conditions.
2. That the Planning Decisions Manager be granted delegated authority to finalise the wording of the conditions to cover the matters in the Recommendation section of this report.

Ref: 24/01437/FUL LOCATION: Enfield District Heat Network, Between Southbury Road EN1, Hertford Road And , St Martins Road



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Scale 1:1250

North



1. Note for Members

- 1.1. The application is reported to the Planning Committee because it is classified as a major development. In addition, the applicant for the development is closely associated with Enfield Council and in accordance with the scheme of delegation, is reported to the Planning Committee for determination.
- 1.2. The applicant acts on behalf of Energetik, a local energy company owned by Enfield Council to supply heat and hot water to homes and businesses across North London.

2. Recommendation

- 2.1. That planning permission be **GRANTED** subject to following conditions.

- 2.2. That the Planning Decisions Manager be granted delegated authority to finalise the wording of the conditions to cover the matters in the Recommendation section of this report.

1. Limited Time Period Permission

The development to which this permission relates must be begun not later than the expiration of three years beginning with the date of the decision notice.

Reason: To comply with the provisions of S.51 of the Planning & Compulsory Purchase Act 2004.

2. Approved Plans

The development hereby permitted shall be carried out in accordance with the approved plans as set out in the attached schedule which forms part of this notice.

5001 Rev C01
8001 Rev C05
3605-VED-00-XX-DWG-CV-011000 Rev A03
3605-VED-00-XX-DWG-CV-011002 Rev A03
3605-VED-00-XX-DWG-CV-011003 Rev A01
3605-VED-00-XXDWG-CV-013002 Rev A04
3605-VED-00-XXDWG-CV-013003 Rev A04
0001 Rev P01
0004 Rev 002
0006 Rev C01
0007 Rev C01
0008 Rev C02
0009 Rev P02
0010 Rev 001
0010 Rev P02
0011 Rev 001
0011 Rev C04
0012 Rev 002
0012 Rev C04

0013 Rev 001
0014 Rev 001
0015 Rev 001
0016 Rev 001
0017 Rev 001
0018 Rev 001
0019 Rev 003
0020 Rev 001
0023 Rev P01
1665-ENF-D3A-00-XX-DR-M-0054D Rev P09
1665-ENF-D3A-00-XX-DR-M-0058 Rev R01
1665-ENF-D3A-00-XX-DR-M-0059 Rev R01
1665-ENF-D3A-00-XX-DR-M-0063 Rev R02
001 Traffic Management Proposal - Montagu Road Jc Conduit Lane
001 Traffic Management Proposal - Kenninghall Road Lane Reduction
001 Traffic Management Proposal - Kenninghall Road Traffic Lights
001 Traffic Management Proposal - Rays Road
Technical Note dated 2 Apr 2024
Planning Statement dated 30 Apr 2024
Energetik Meridian Water Heat Network Zone 1A - Management of Contaminated Ground Rev 4
Phase 1 Arboricultural Impact Assessment Version 4.0 dated 24 May 2024
Construction Environmental Management Plan dated Mar 2024
Ecological Management Plan dated Mar 2024
Ecological Assessment Version 2.0 dated Apr 2024
Biodiversity Net Gain Report Version 2.0 dated Apr 2024
Biodiversity Net Gain Metric
BNG Declaration Form
Archaeological Desk-Based Assessment dated Mar 2024
Written Scheme of Investigation for Archaeological Observation dated Apr 2024
Sustainable Urban Drainage Method Statement
Flood Risk Assessment Report

Reason: For the avoidance of doubt and in the interests of proper planning.

3. Air Quality

All Non-Road Mobile Machinery (NRMM) of net power of 37kW and up to and including 560kW used during the course of the demolition, site preparation and construction phases shall comply with the emission standards set out in chapter 7 of the GLA's supplementary planning guidance "Control of Dust and Emissions During Construction and Demolition" dated July 2014 (SPG), or subsequent guidance. Unless it complies with the standards set out in the SPG, no NRMM shall be on site, at any time, whether in use or not, without the prior written consent of the local planning authority. The developer shall keep an up to date list of all NRMM used during the demolition, site preparation and construction phases of the development on the online register at <https://nrmm.london/>

Reasons: In the interests of good air quality with regard to London Plan (2021).

4. Contamination Compliance

The development shall be undertaken in accordance with Energetik Meridian Water Heat Network Zone 1A - Management of Contaminated Ground Rev 4

and shall be carried out in accordance with the contaminated management measures set out in the aforementioned document.

Reason: To avoid risk to public health and the environment.

5. Unidentified Contamination

If, during development, contamination not previously identified is found to be present at the site then no further development (unless otherwise agreed in writing with the Local Planning Authority) shall be carried out until the developer has submitted and obtained written approval from the Local Planning Authority for, an amendment to the remediation strategy detailing how this unsuspected contamination shall be dealt with.

Reason: To protect against risks arising from contamination

6. Tree Protection Compliance

The development shall be undertaken in accordance with Phase 1 Arboricultural Impact Assessment Version 4.0 dated 24 May 2024 and shall be carried out in accordance with tree protection and mitigation measures set out in the aforementioned document.

Reason: To ensure trees to be retained will not be damaged during construction works and to protect and enhance the appearance and character of the site and locality, in accordance with DMD 80 and pursuant to section 197 of the Town and Country Planning Act 1990.

7. Construction Environmental Management Plan Compliance

The development shall be carried out in accordance with the Construction Environmental Management Plan dated March 2024.

Reason: To minimise impacts on biodiversity in accordance with Paragraph 180 of the NPPF (2023), Policy G6 of the London Plan (2021) and Policy CP 36 of the Core Strategy (2010).

8. Ecological Enhancement measures

The ecological enhancement measures detailed in section 5.0 of Appendix A of the Construction Environmental Management Plan dated March 2024 shall be implemented in full and prior to first use of the development a concise report, including a plan and photos of the ecological enhancement measures shall be submitted to and approved in writing by the local planning authority.

Reason: To protect and enhance biodiversity in accordance with Paragraph 180 of the NPPF (2023), Policy G6 of the London Plan (2021) and Policy CP 36 of the Core Strategy (2010).

9. River Culverts

No works approved by this application within an individual development zone or section shall commence until a detailed condition survey is undertaken of any main river culverts where the proposed pipework crosses or passes within 8

meters. The survey(s) will be submitted to, and approved by, the local planning authority in consultation with the Environment Agency.

Details of any improvement works shall be included along with proposed timings. Any required maintenance or replacement of the culverts will need to be undertaken prior to construction of any heat network infrastructure within 8 meters of a main river.

Reason: The current condition of the culverts is unknown and could be impacted by the proposed construction works. A collapse of a culvert can cause considerable flooding to the area. To prevent this, the applicant must demonstrate the current condition of the culvert and any improvement works required to ensure the structural integrity will not be compromised.

3. Executive Summary

- 3.1. The application site concerns the areas around Kenninghall Open Space. The application seeks approval for the diversion of the approved first phase of a decentralised energy network that will eventually cover large areas of the London Borough of Enfield and some areas of neighbouring London Boroughs.
- 3.2. Decentralised energy networks are encouraged and supported in local, regional, and national planning policies and major developments are required to connect to existing or planned energy networks whenever possible. Several major developments within the Borough have already installed or are installing the equipment and infrastructure necessary to connect to the subject energy network.
- 3.3. The proposed diverted route would be circa 500m within the approved 7km first phase network. The first phase network extends from the Meridian Water/Edmonton area in the south of the Borough towards the north. There will be three phases following this phase to complete the total 23km pipeline network.
- 3.4. The Energetik/Lee Valley Heat Network is supplied with energy from the adjacent EcoPark/North London Heat and Power Project facility to the north, which generates energy from waste.
- 3.5. The primary reasons for recommending approval are:
 - The development and expansion of low carbon decentralised energy networks is strongly supported throughout all levels of planning policy.
 - The development would form part of the decentralised energy network, which is both encouraged and required by local and regional plans and policies and enables the wider delivery of actual service to progress. It will facilitate further expansion of the network as well, allowing development in the future to benefit from connecting to the network.
 - The development complies with relevant planning policy where identified in this report, or compliance can be ensured through the use of planning conditions that have been proposed.
- 3.6. The proposal is considered acceptable in particular having regard to Policies GG1, SI2, and SI3 of the London Plan, Policy CP20 of the Core Strategy and Policies 51 and 52 of the Development Management Document.

4. Site and Surroundings

- 4.1. The subject site concerns a diversion of an approved pipe network connected to the district heat network. The approved pipe network spans across several wards and is approximately 7km in length. The vast majority of the piping will be located within the public highway, buried under road and pedestrian surfaces.

- 4.2. The proposed diversion relates only to the south section of the approved Phase 1 route A1A (as indicated in Figure 1) comprising the areas along Rays Road, Montagu Road and Kenninghall Road, and then a further diversion under the North Circular Road (A406) (as indicated in Figure 3).
- 4.3. The diverted area covers the following planning designations:
 - Edmonton Leeside Area Action Plan
 - Place Shaping Priority Area
 - Locally Significant Industrial Site
 - Flood Zones 2, 3 and 3b
- 4.4. Kenninghall Open Space, where the diversion would only run along its fringe, is a Local Open Space.
- 4.5. Figures 1 and 2 depict the approved route whilst Figure 3 depicts the proposed amended route:

[see next pages]

Figure 1 – Approved route: Beginning near Meridian Water in the south and running north

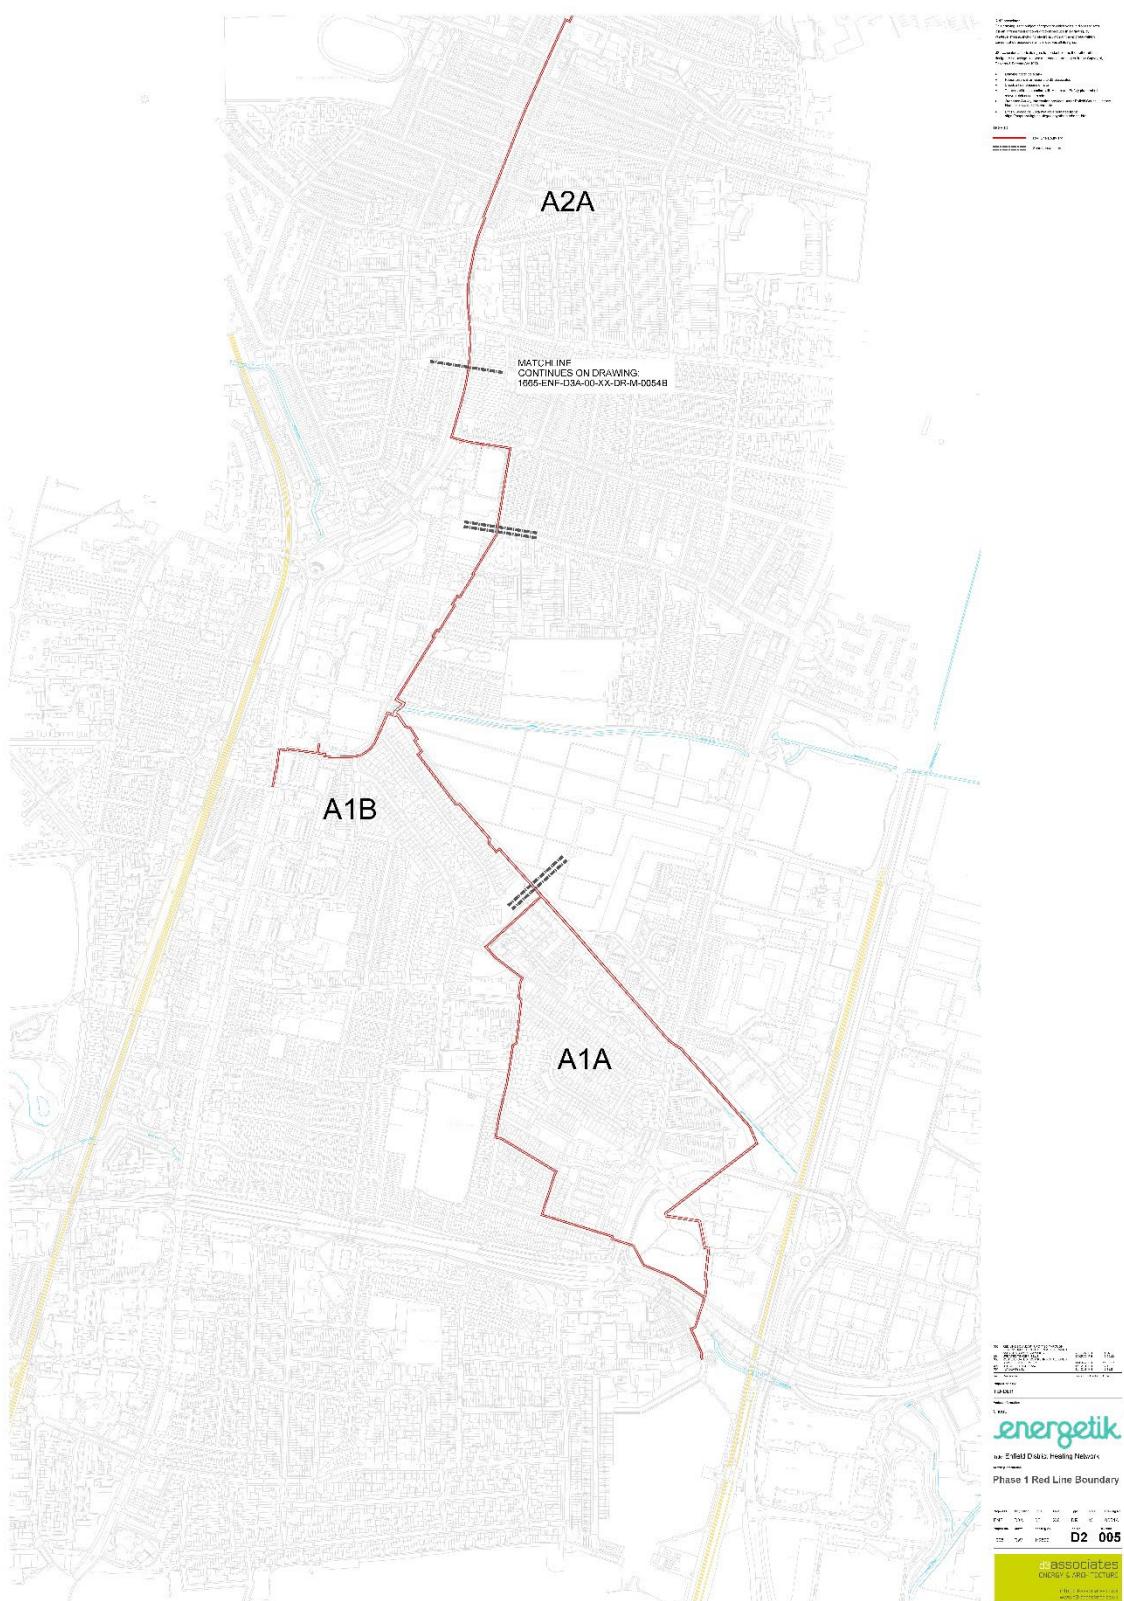


Figure 2 – Approved route: Continuing north from proceeding drawing


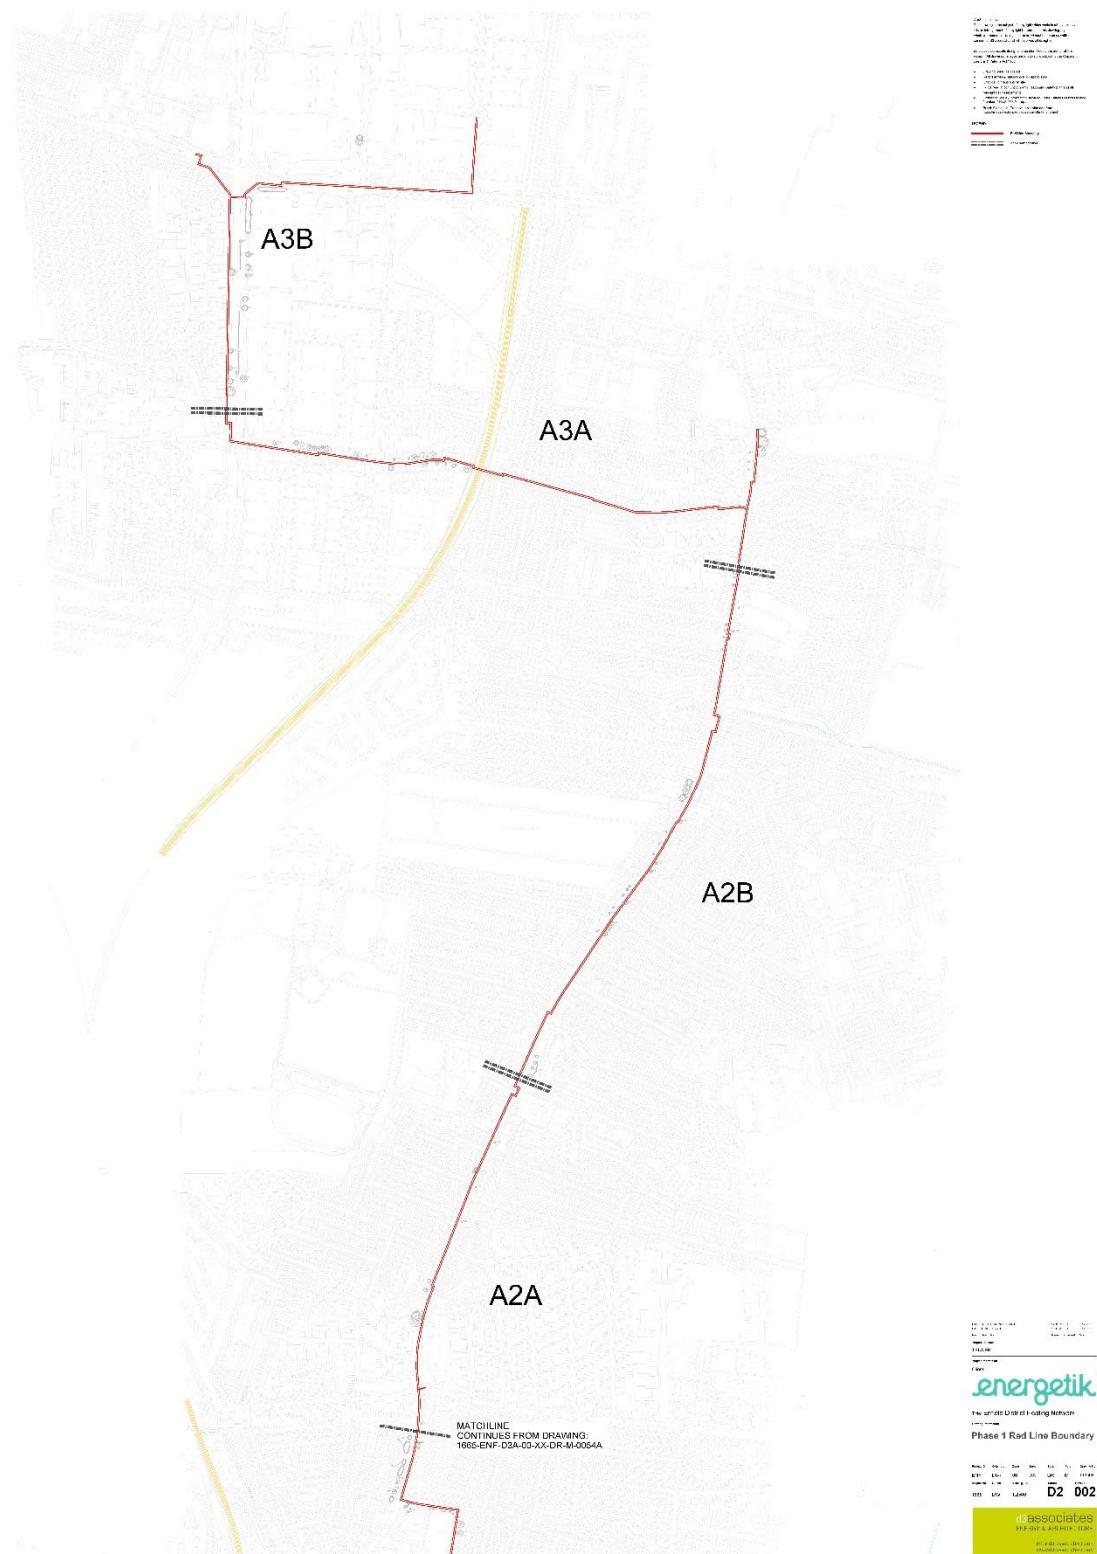


Figure 3 – Proposed diversion

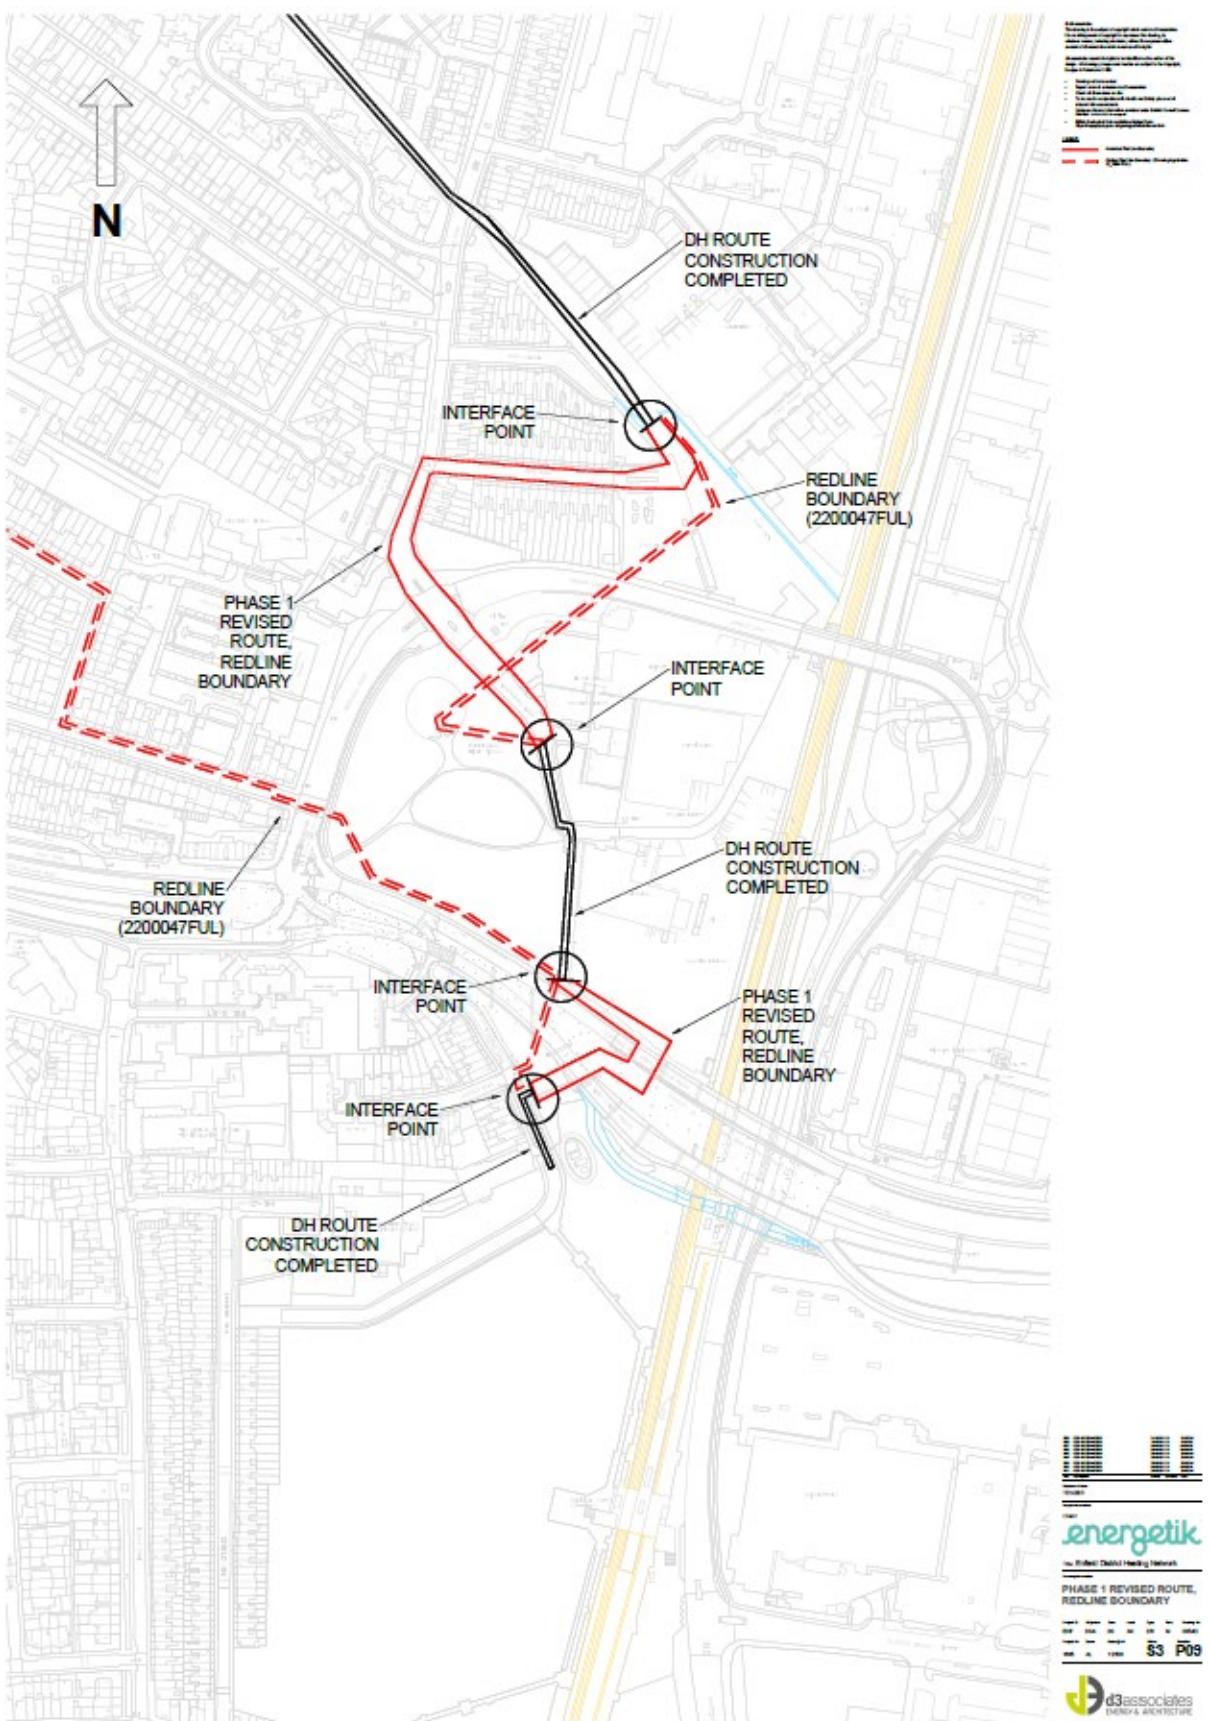

5. Proposal

- 5.1. The proposal seeks to divert the approved heating pipe network. The diverted sections measure circa 500m. There would be two sections of diversion (north and south) which would be connected to the constructed network. The north section would avoid the need to run into Kenninghall Open Space, which was previously approved. Instead, the proposed route would run along Rays Road and Kenninghall Road, briefly aligning with the approved route along Kenninghall Road, before taking another diversion passing under A406 North Circular and crossing above Pymmes Brook (south section of diversion).
- 5.2. The majority of the pipework would be installed within the carriageway with at least 800mm cover to the crown of the pipe. Part of the south section would cross above the culvert of Pymmes Brook with steel pipe support structures
- 5.3. Two cabinets would be erected along the diverted pipeline, one being located on Kenninghall Road and the other one being located on Albany Road. The cabinets would measure 836mm in height, 600mm in width and 260mm in depth, painted in green.

6. Relevant Planning History

- 6.1. The following is the primary planning application associated with the district heat network.

| Reference | Description | Decision | Date |
|--------------|---|------------------------------|-----------------|
| 18/04517/FUL | Construction of a new district heating energy centre building and phase 1 of the associated buried heat network piping which extends westward into the wider borough. | S106 Granted with Conditions | 11 January 2021 |

Officer Note: This was an application for Energetik's operational hub for the decentralised energy network pipes and an extension of the piping to Meridian Water. This was also called phase 1 but was specific to an extension to Meridian Water.

The energy centre building is located at 4 Advent Way, to the north of the North Circular Road.

- 6.2. The following are similar, albeit smaller scale applications to extend piping to connect to various developments, in anticipation of the full decentralised energy network being built.

| Reference | Description | Decision | Date |
|--------------|--|-------------------------|-----------------|
| 19/02282/FUL | Installation of district heating pipework. | Granted with Conditions | 24 October 2019 |

Officer Note: This was an application to install connecting pipework between Alma Estate and the Electric Quarter for future connection to the wider decentralised energy network.

| | | | |
|--------------|--|-------------------------|--------------|
| 21/02036/FUL | Installation of district heating pipework and all associated works including pipework and connections on external elevations of properties | Granted with Conditions | 29 July 2021 |
|--------------|--|-------------------------|--------------|

Officer Note: This application was associated with properties along Naylor Grove, EN3.

| | | | |
|---|---|-------------------------|-------------------|
| 21/02587/FUL | Installation of district heating pipework and all associated works including pipework and connections on external elevations of properties. | Granted with Conditions | 16 September 2021 |
| Officer Note: This application was associated with properties along South Street, EN3. | | | |
| 22/00013/RE4 | Extension of Ponders End Heat Network to supply low carbon heat to the Swan Annexe. | Granted with Conditions | 17 March 2022 |
| Officer Note: This application was associated with properties at Swan Annexe, adjacent to High Street, Ponders End. | | | |

6.3. The following relates to the proposals which the current proposal now seeks to amend.

| Reference | Description | Decision | Date |
|--|--|-------------------------|-----------------|
| 22/00047/FUL | Phase 1 of new 23km Borough-wide district heating distribution network in Enfield comprising at this stage pipework of approximately 7km in length. | Granted with Conditions | 3 October 2022 |
| 22/03867/CND | Details pursuant to ref: 22/00047/FUL: Contamination (5) for Phase 1 of new 23km Borough-wide district heating distribution network in Enfield comprising at this stage pipework of approximately 7km in length. | Granted | 26 January 2023 |
| 22/04214/CND | Details pursuant to ref: 22/00047/FUL: Archaeology (3) for Phase 1 of new 23km Borough-wide district heating distribution network in Enfield comprising at this stage pipework of approximately 7km in length. | Granted | 17 January 2023 |
| 23/00383/CND | Details pursuant to ref: 22/00047/FUL: Construction Environmental Management Plan (8) for Phase 1 of new 23km Borough-wide district heating distribution network in Enfield comprising at this stage pipework of approximately 7km in length. | Granted | 27 January 2023 |
| 23/01293/CND | Details pursuant to Ref: 22/00047/FUL for River Culverts-Special Inspection Report (7) in respect of Phase 1 of new 23km Borough-wide district heating distribution network in Enfield comprising at this stage pipework of approximately 7km in length. | Withdrawn | |
| Officer Note: 22/00047/FUL is the original application to which the current application seeks amendments. The rest of the applications in this table are the discharge of condition applications associated with the original application. | | | |

7. Consultation

Statutory and Non-Statutory ConsulteesInternal

- 7.1. Ecology:
No objections.
- 7.2. Environmental Health:
No objections.
- 7.3. Highway Services:
No objections.
- 7.4. Flood risk and SuDS:
No objections.
- 7.5. Heritage
No objection
- 7.6. Tree:
No objections.

External

Cadent Gas: No comments received.

- 7.7. Environment Agency:
No objections. Flood Risk Activity Permit should be applied separately.
- 7.8. Historic England (GLASS):
The consultee does not consider this application necessary to be notified nor suggest any pre-commencement conditions.
- 7.9. Natural England:
No objections.
- 7.10. Thames Water: No comments received.
- 7.11. Transport for London:
No objections.

Public Consultation

- 7.12. Consultation letters dated 16 May 2024 were sent to 90 neighbouring and nearby properties. Notice was also displayed at the site (dated 15 May 2024) and published in the local press (dated 22 May 2024).
- 7.13. In response no representations have yet been received. Any comments received will be reported at the meeting.

8. Relevant Planning Policies

8.1. Section 70(2) of the Town and Country Planning Act 1990 requires the Committee have regard to the provisions of the development plan so far as material to the application: and any other material considerations. Section 38(6) of the Planning and Compulsory Purchase Act 2004 requires planning decisions to be made in accordance with the development plan unless material considerations indicate otherwise.

8.2. National Policy

National Planning Policy Framework 2023 (NPPF)
National Planning Practice Guidance (PPG)

8.3. London Plan (2021)

The London Plan together with Enfield's Local plan forms the Development Plan for this application. It is the overall strategic plan for London setting out an integrated economic, environmental, transport and social Framework for the development of London for the next 20-25 years. The following policies of the London Plan are considered particularly relevant:

GC6: Increasing efficiency and resilience
D4: Delivering good design
HC1: Heritage conservation and growth
G6: Biodiversity and access to nature
G7: Trees and woodlands
SI 1: Improving air quality
SI 2: Minimising greenhouse gas emissions
SI 3: Energy infrastructure
T1: Strategic approach to transport

1.1. Core Strategy (2010)

The Core Strategy was adopted in November 2010 and sets out a spatial planning framework for the development of the Borough through to 2025. The document provides the broad strategy for the scale and distribution of development and supporting infrastructure, with the intention of guiding patterns of development and ensuring development within the Borough is sustainable. The following policies of the Core Strategy is considered particularly relevant:

CP 20: Sustainable Energy Use and Energy Infrastructure
CP 30: Maintaining and Improving the Quality of the Built and Open Environment
CP 31: Built and Landscape Heritage
CP 36: Biodiversity

1.2. Development Management Document (2014)

The Council's Development Management Document (DMD) provides further detail and standard based policies by which planning applications should be determined. Policies in the DMD support the delivery of the Core Strategy. The following local plan Development Management Document policies are considered particularly relevant:

- DMD 37: Achieving High Quality and Design-Led Development
- DMD 44: Conserving and Enhancing Heritage Assets
- DMD 51: Energy Efficiency Standards
- DMD 52: Decentralised Energy Networks
- DMD 80: Trees on Development Sites

8.4. Edmonton Leeside Area Action Plan (2020)

- EL17: Redevelopment of the EcoPark Site
- EL26: The Meridian Water Heat Network

8.5. Other material considerations

- Decentralised Energy Network Technical Specification SPD (2015)

8.6. Emerging Local Plan

The Council published the Enfield Local Plan 2019-2041 for Regulation 19 Consultation between 28 March and 20 May 2024. The Enfield Local Plan is at an advanced stage of preparation and is considered by the council to be sound and will not be modified significantly prior to examination. The NPPF Paragraph 48 states that decision-makers may give weight to relevant policies in emerging plans according to their stage of preparation, the extent to which there are unresolved objections to relevant policies, and their degree of consistency with policies in the NPPF 3. For example, a policy that receives few objections at the Regulation 19 consultation can be given more weight than a policy that receives many objections. As such, policies must be considered on a case-by-case basis for larger schemes during the consultation and examination period and the weight given to specific policies must be determined at the time a decision is made. Enfield's adopted Development Plans remain the starting point for decision making until the new Enfield Local Plan is adopted.

9. **Analysis**

9.1. The main issues arising from this proposal to consider are:

- Principle of development
- Character and appearance of the site and surrounding area
- Environmental health
- Transportation and highways
- Trees and ecology
- Drainage and flooding
- Archaeology

Principle of Development

- 9.2. The principle of installing and strategically expanding decentralised energy networks and associated infrastructure is fully supported and encouraged by policy DMD 52 of the Enfield Development Management Document (2014) and CP 20 of the Enfield Core Strategy (2010), as well as the Enfield Decentralised Energy Network Technical Specification Supplementary Planning Document (2015). The National Planning Policy Framework and policy SI3 of the London Plan (2021) further reinforce the support for decentralised energy networks.
- 9.3. Decentralised energy networks generate energy at the point of distribution, in this case an existing energy from waste facility that is currently being replaced and upgraded with modernised technology and methods. Power and/or heat is then distributed in a network of underground pipelines.
- 9.4. Policies DMD 51 and DMD 52 require new developments to connect to decentralised networks if nearby, contribute towards extensions of the network if feasible to do so, or if the network does not yet exist but is planned then to commit to connect to the network in the future when available.
- 9.5. The principle of the development of the application decentralised energy network has been agreed upon in the previous application 22/00047/FUL. The current proposal to divert part of the network would be consistent with the approved principle.

Character and appearance of the site and surrounding area

- 9.6. The north section of the diversion would be laid underground. The south section would rise from below ground, supported by concrete foundations and headwalls running underneath the A406 North Circular and above Pymmes Brook. The majority of the above ground piping would be enclosed by 2m high fencing.
- 9.7. The above ground piping in the south section would be mainly located in an undeveloped area underneath the North Circular. The area, which is located within a Locally Significant Industrial Site, is mainly industrial with limited distinctive character. Therefore, the proposed structure would not adversely impact the appearance and the character of the local area.
- 9.8. Two cabinets would be erected along the diverted pipeline, one being located on Kenninghall Road and the other one being located on Albany Road. The cabinets would measure 836mm in height, 600mm in width and 260mm in depth, painted in green. It is considered that they would be in discreet locations and given the size of the cabinet, they would have limited visual impact.

Environmental Health

Air quality

- 9.9. Policy SI 1 of the London Plan (2021) requires that development proposals control, and where possible improve, air quality within London. The proposed diversion concerns only 500m of the approved network. Given the scale of the development, it is considered that the proposal would not significantly impact air quality. The Council's Environmental Health Officer raised no objection in this regard. A condition is applied to require non-road mobile machinery to comply with the GLA's supplementary planning guidance Control of Dust and Emissions During Construction and Demolition (2014) to control dust during construction works.

Contamination

- 9.10. A contamination management plan has been submitted along with the application. The Environmental Health Officer is satisfied with the measures suggested in the management plan and considers the measures to be sufficient. A condition is applied to require the compliance of the management plan.
- 9.11. As conditioned, it is considered that the proposal will not negatively impact the environment in the context of air quality and contamination.

Transportation and Highways

- 9.12. The north section of the diverted piping will be located within the public highway. As such, it will require temporary traffic control measures to ensure the safety of road users and efficiency of movement.
- 9.13. The Council's Highways department recognised that the proposal has no long term effects on either highway usage or amenity. In addition to the south section which would run underneath the Transport for London structure on A406 North Circular, the management of the actual execution of works will be controlled by licensing in accordance with Section 50 of the New Roads and Street Works Act 1991, which is a separate process from granting planning permission.
- 9.14. It will be the responsibility of the developer to enter into agreements with the Council as the Highway Authority and Transport for London to ensure any construction related impacts to the movement and free flow of traffic will be managed and sufficiently mitigated.

Trees and ecology

- 9.15. There is no Tree Protection Order in place within or near the diverted area. An Arboricultural Impact Assessment (AIA) has been submitted by the applicant. The AIA includes survey data, survey methods, tree constraints plans, tree works plans, tree protection plans, and tree protection fencing specifications.
- 9.16. The proposal would not propose any tree removal. Group trees G41 (Category C) would be in close proximity to the north section of the diversion. The AIA suggests open trench excavations which can be micro-sited on the site to avoid conflicts with root protection area.
- 9.17. The Council's Tree Officer was consulted and raised no objection to the proposal and the tree protection and root pruning methods.

- 9.18. The proposed diversion does not cover any ecological sensitive areas. The diversion would avoid running through the Kennington Open Space as in the approved route.
- 9.19. The application suggests appropriate precautionary measures to protect woodland, trees, nesting birds, hedgehogs, reptiles and other protected species and measures to stop the spread of non native invasive species. The proposal also includes enhancement measures such as bird and bat boxes, reptile hibernacula, logger, hedgehog brash piles and wildlife sensitive management. An appointed ecologist has been consulted and raised no objections to the proposed ecological measures and enhancement. Conditions are imposed to ensure compliance with these measures identified in the Construction Environmental Management Plan.
- 9.20. As such, with the appropriate conditions, the proposal is found to be acceptable in this regard and would not result in adverse impact to trees and ecology.

Drainage and Flooding

- 9.21. Given the development consists of underground piping and minor above ground structures, including cabinets and concrete support structure in the south section, the impact on flood risk and drainage would be limited. The Council's Flood Risk and Sustainable Drainage Officer raised no objections to the proposal

Archaeology

- 9.22. The applicant submitted a desk-based archaeology report and a written scheme of investigation. The Greater London Archaeological Advisory Service (GLASS) at Historic England was consulted and noted that due to the scale of the development and the diverted area not falling within an archaeological priority area, the GLASS would not comment on the proposal or require any pre-commencement condition in this regard.

10. The Community Infrastructure Levy (CIL)

- 10.1. In this case, due to the nature of the development, the proposal would not be liable to pay the Council's CIL or the Mayoral CIL.

11. Public Sector Equality Duty

- 11.1. In line with the Public Sector Equality Duty the Council must have due regard to the need to eliminate discrimination and advance equality of opportunity, as set out in section 149 of the Equality Act 2010. Section 149 of the Act requires public authorities to have due regard to several equality considerations when exercising their functions including decision making on planning applications. It is considered that the proposal to grant planning permission for this development would not disadvantage people who share any of the different nine protected characteristics compared to those who do not have those characteristics and therefore it is considered that the development would not have a disproportionate equalities effect. Accordingly, the recommendation is considered appropriate in upholding the council's adopted and emerging policies and is not outweighed by any engaged rights.

12. Conclusion

- 12.1. Strategic national, regional, and local policies are supportive of the delivery of decentralised energy networks. This application is for the diversion of the approved first major phase of underground infrastructure to enable the provision of reliable and sustainable energy and allow for future extension of the network. It is considered that the proposed diverted route is in appropriate locations with limited visual impact. The proposal would successfully mitigate transportation, tree, ecology, archaeology and contamination issues that may arise through the requirements of the suggested conditions or by following the plans put forth by the applicant.
- 12.2. The proposal is therefore recommended for approval subject to the recommended conditions.



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001 TENDER ISSUE 10.12.21 PH 10.12.21
Rev Description Issued Checked Date

Purpose of issue
TENDER

Project Information

Client:

energetik

Title: Enfield District Heating Network


Drawing Information

**District Heating Network
Phase 1 Overall Scheme**

| Project ID | Originator | Zone | Level | Type | Role | Drawing No. |
|-------------|------------|------------|-------|--------|----------|-------------|
| ENF | D3A | 00 | XX | DR | M | 0010 |
| Project No. | Drawn | Scale @ A1 | | Status | Revision | |
| 1665 | DW | NA | | D2 | 001 | |

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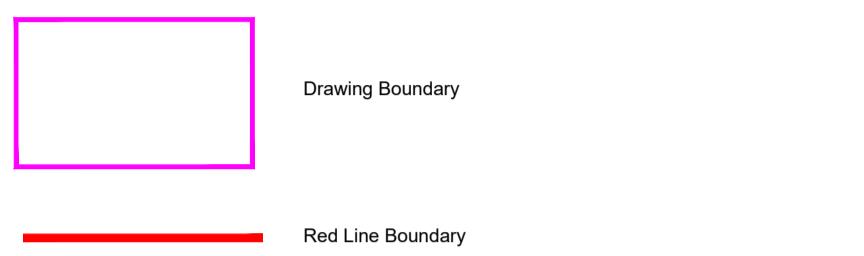


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AND ALL RELEVANT RISK ASSESSMENTS

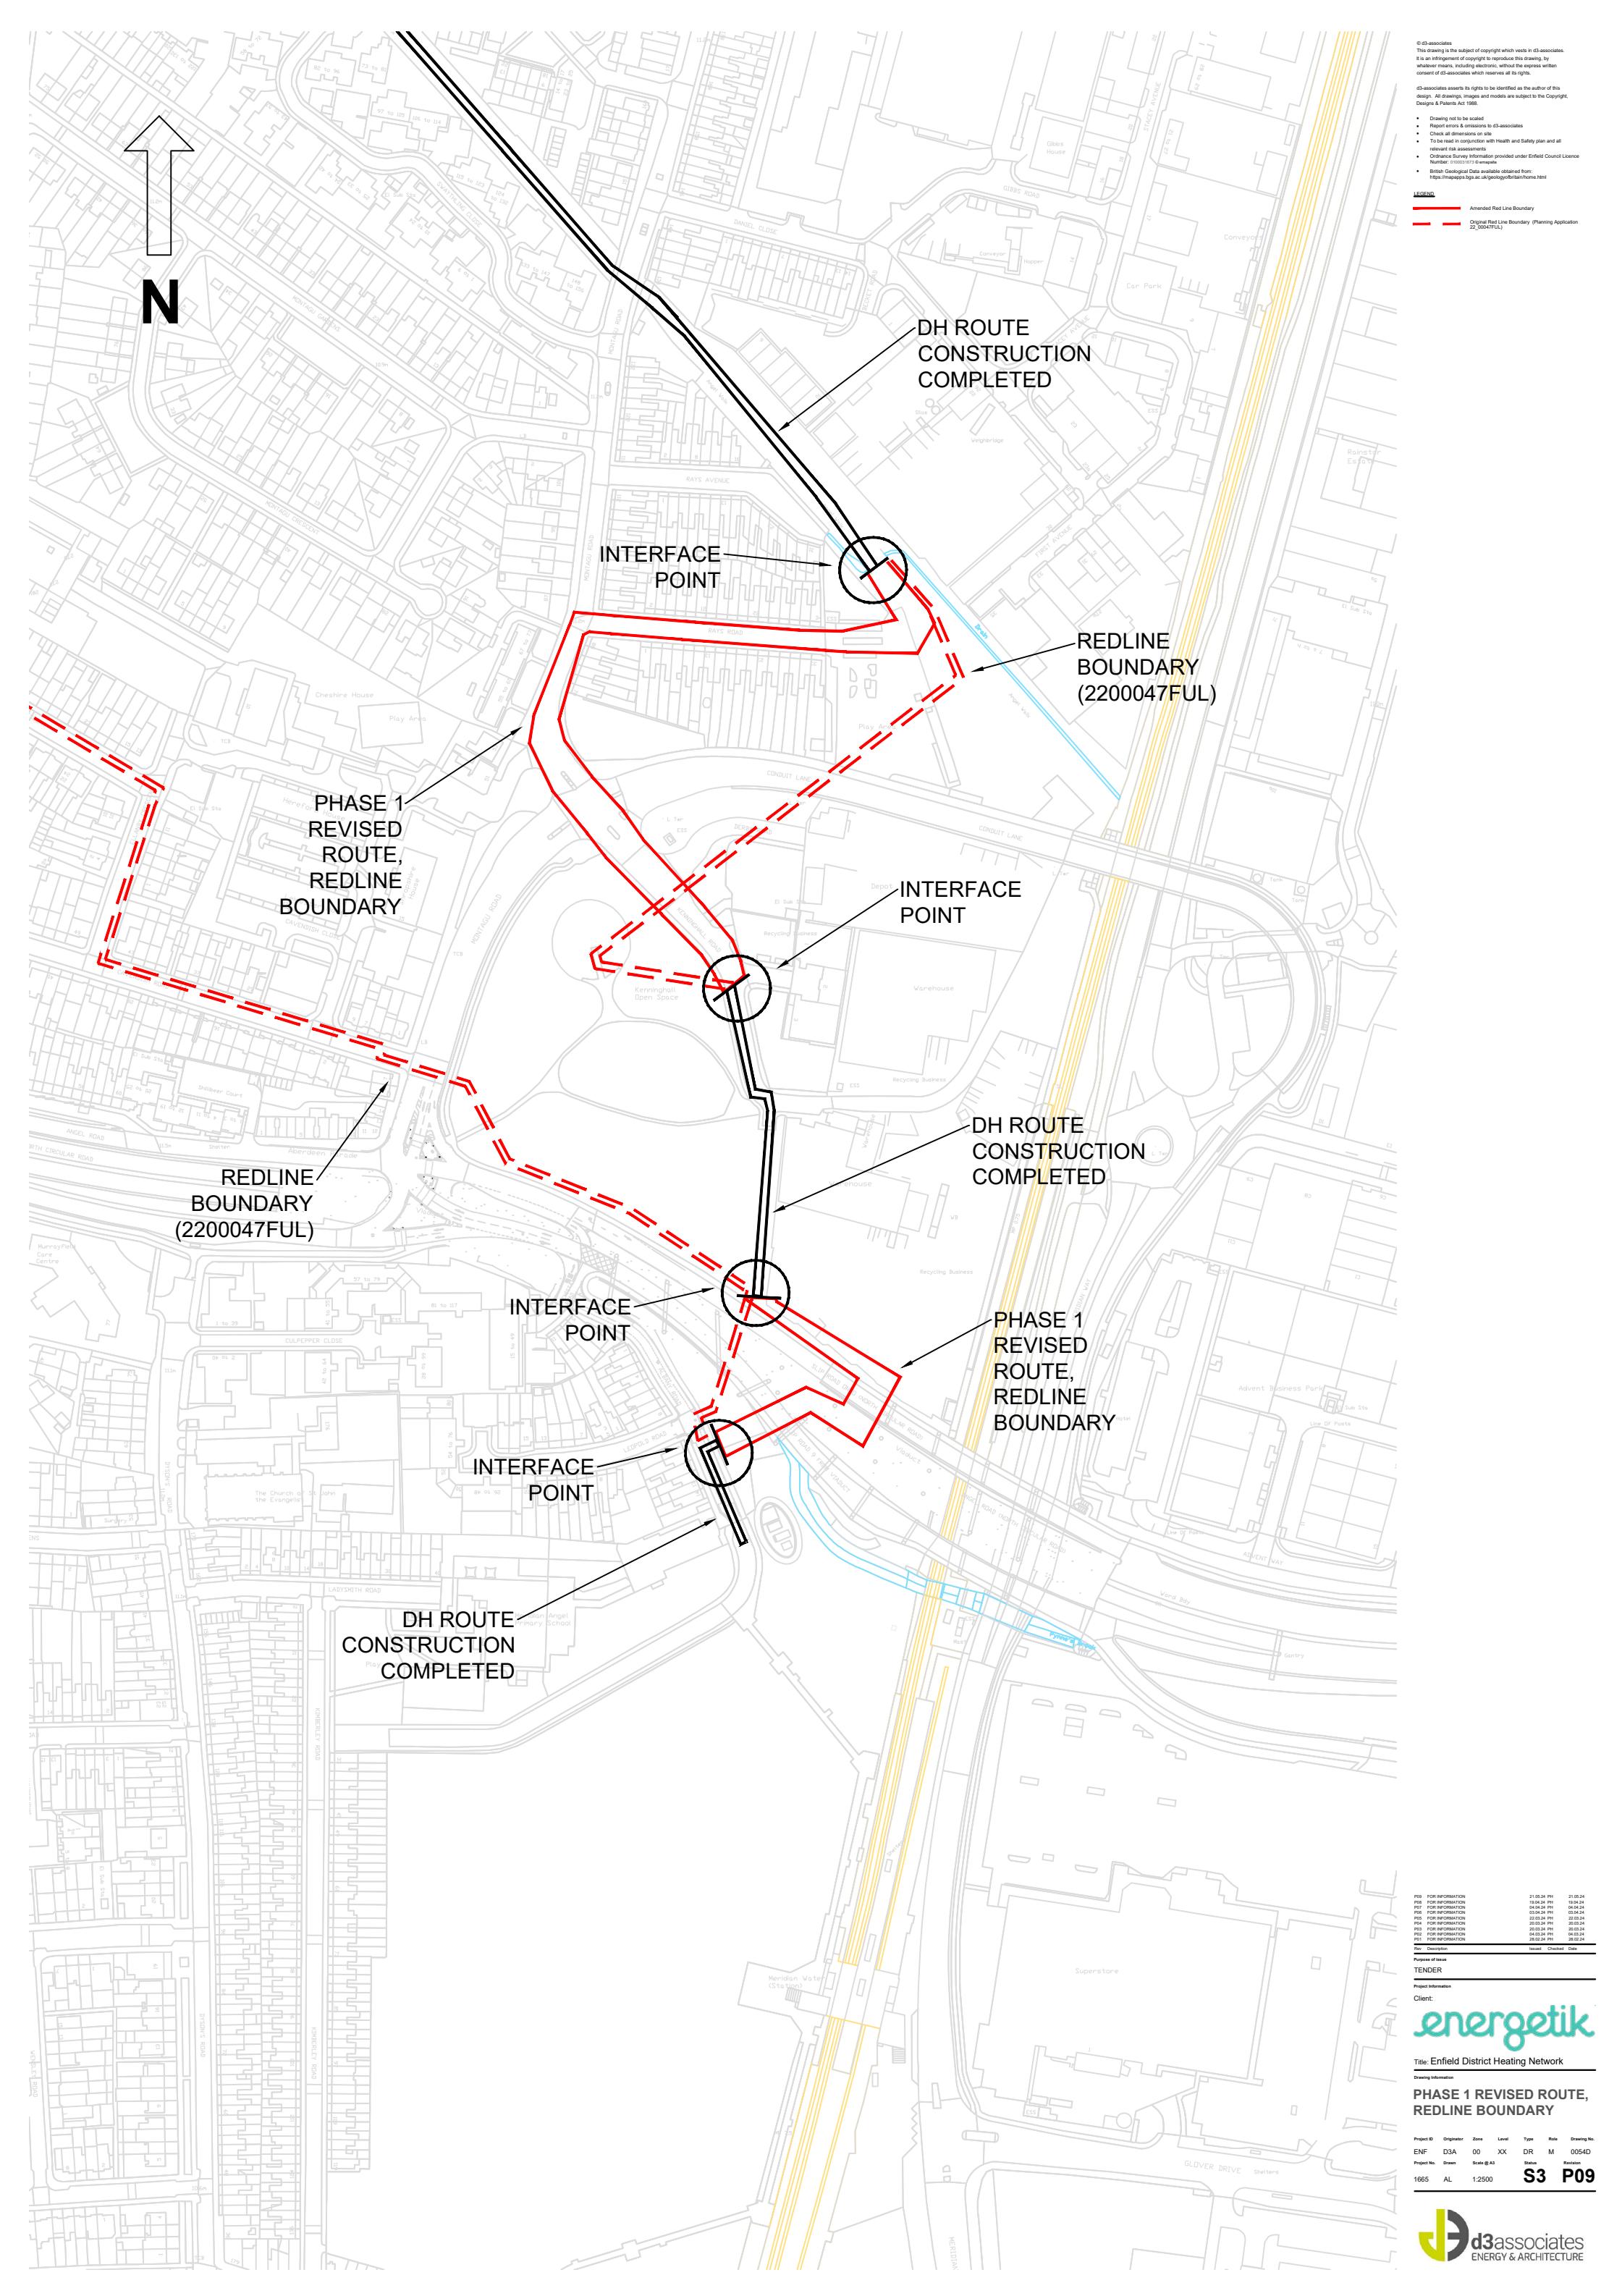LEGEND



| | | | |
|-------------------|--------|---------|----------|
| 2 FOR INFORMATION | PH | PH | 24.05.24 |
| 1 FOR INFORMATION | PH | PH | 22.05.24 |
| V DESCRIPTION | ISSUED | CHECKED | DATE |

POSE OF ISSUE OR INFORMATION

ENFIELD DISTRICT HEATING NETWORK

WING INFORMATION

PHASE 1 DRAWING OVERVIEW WITH EDLINE BOUNDARY

WING NO.
665-ENF-D3A-00-XX-DR-M- 0063

| JECT NO. | DRAWN | SCALE @ A1 | STATUS | REVISION |
|----------|-------|------------|--------|----------|
| 665 | AL | 1 : 1000 | S2 | R02 |

[View Details](#) | [Edit](#) | [Delete](#)


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ENERGY & ARCHITECTURE

ENERGY & ARCHITECTURE

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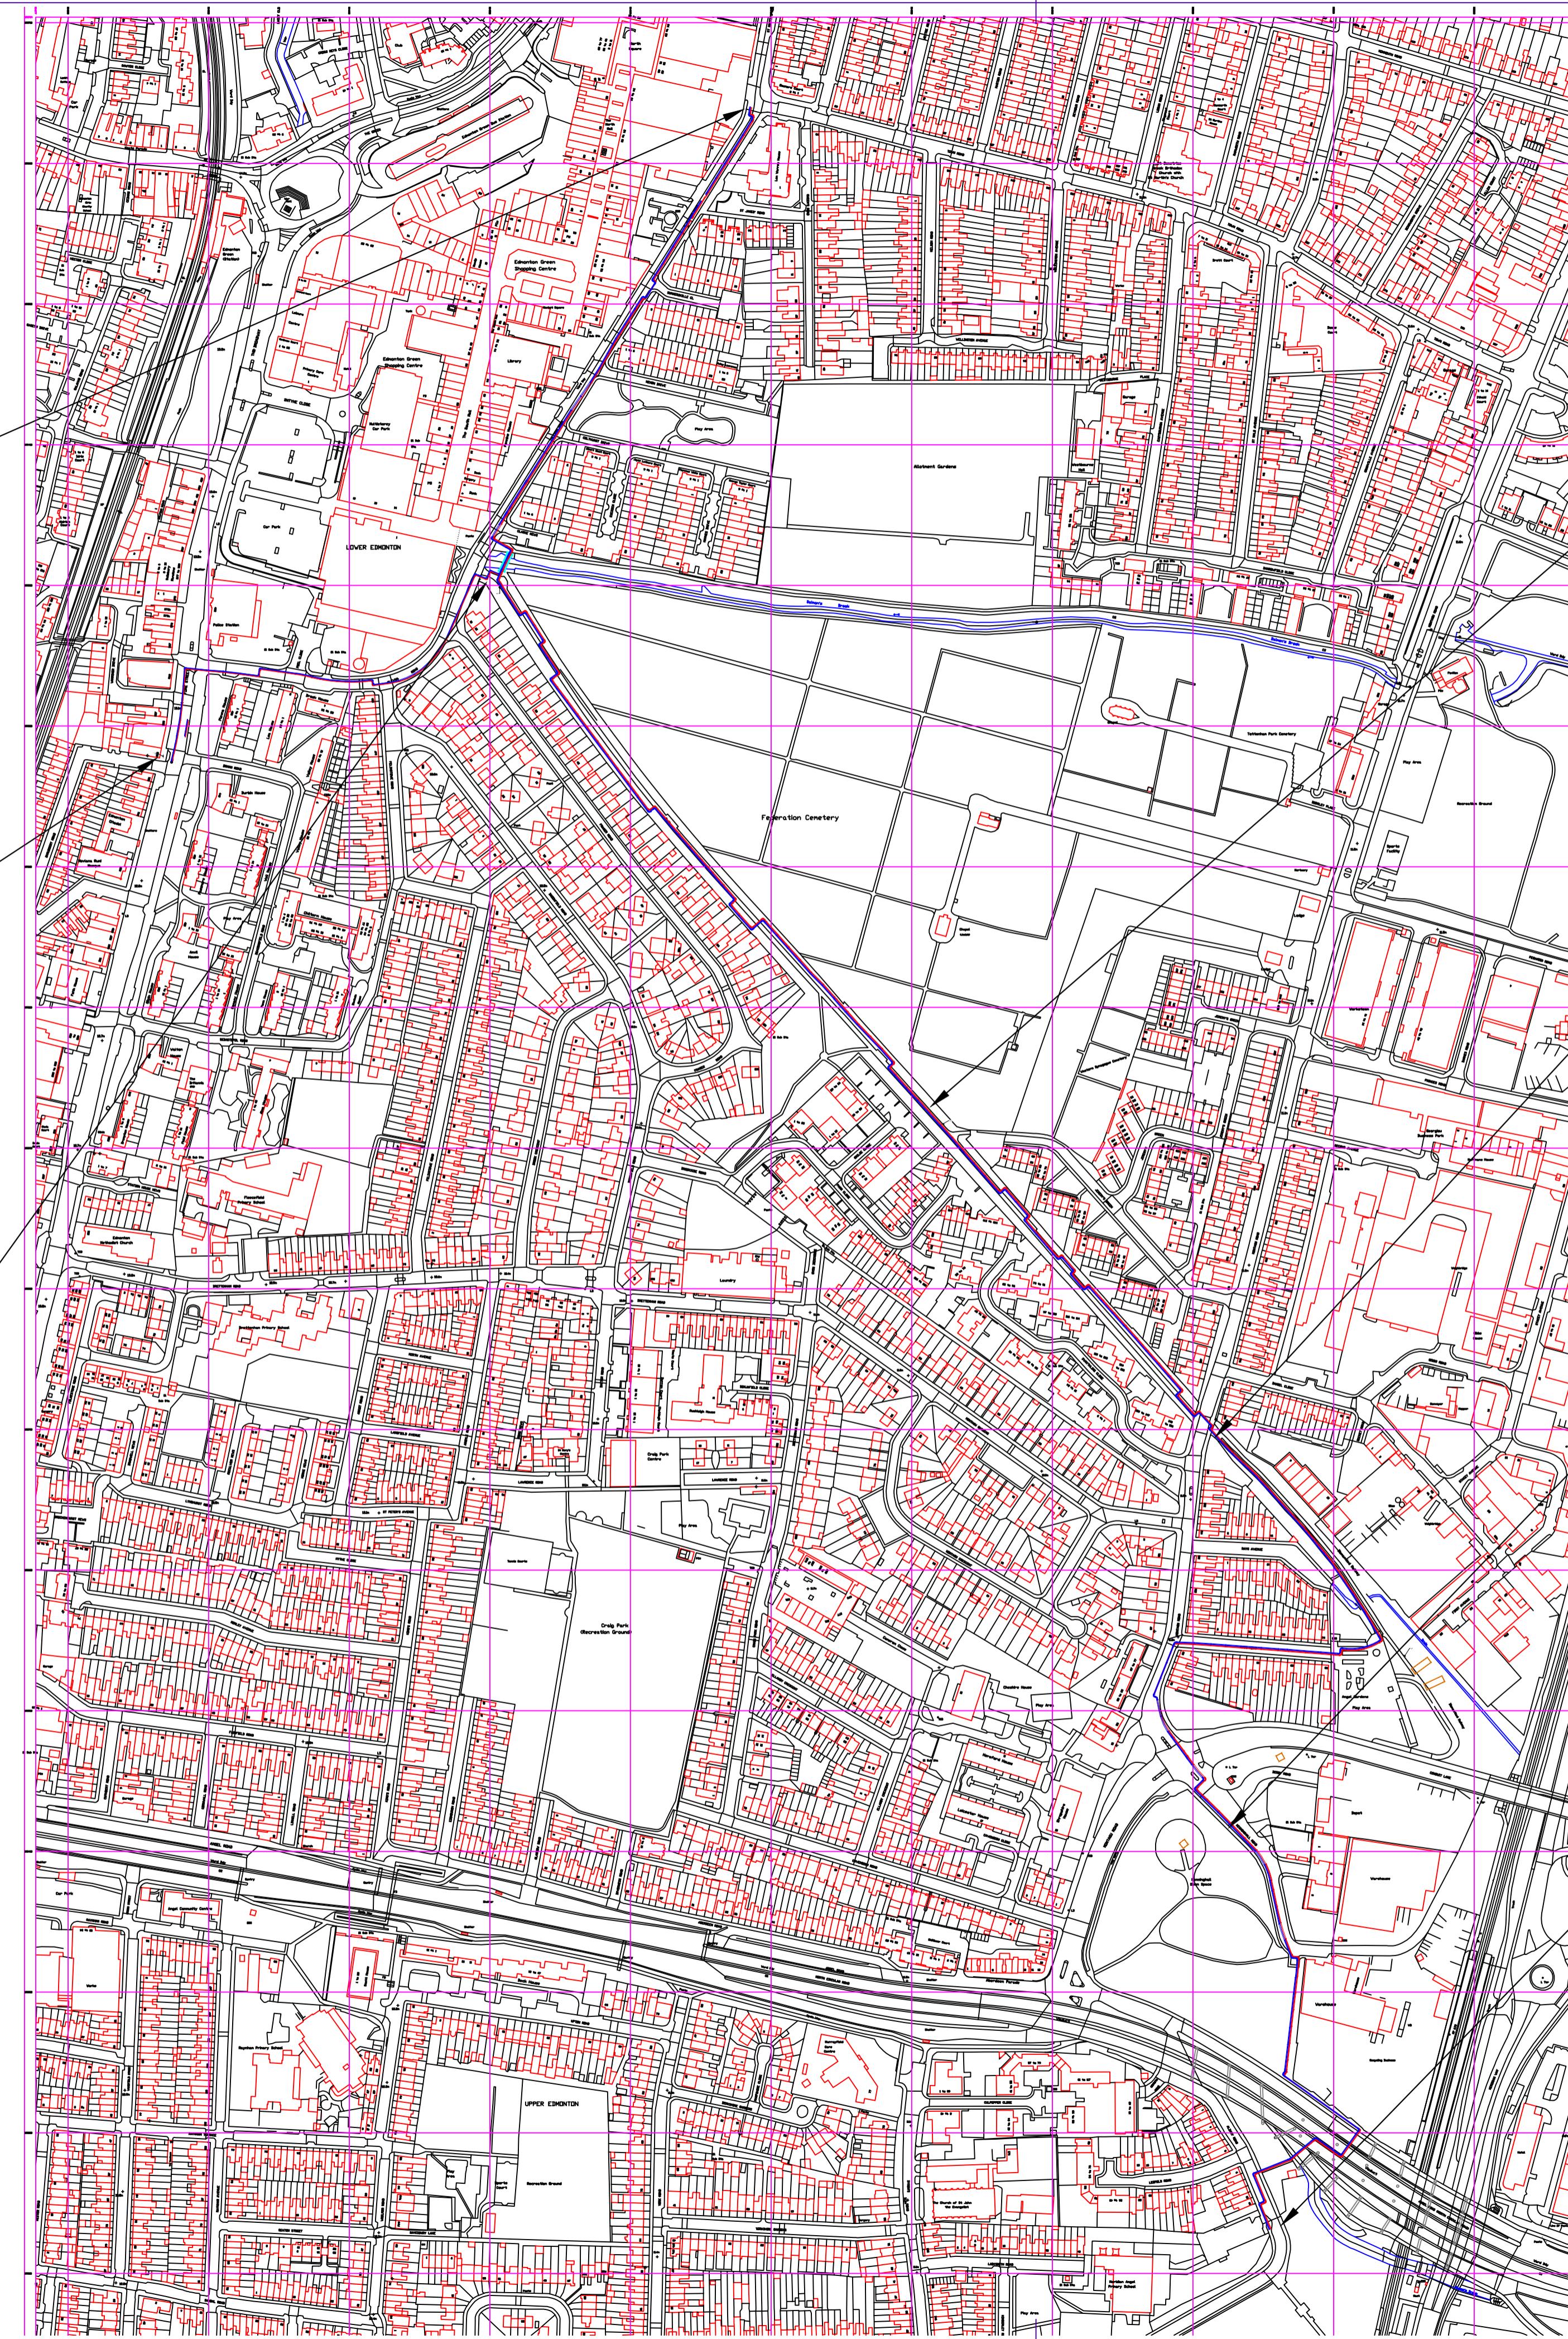
TP1007 Plevna Road/Town Road Junction Test Point Cabinet Location
Map Co-ordinates E. 534678.378 N. 193634.399



TP1021 Fore Street/Shrubbery Road Test Point Cabinet Location
Map Co-ordinates E. 534264.255 N. 193177.281

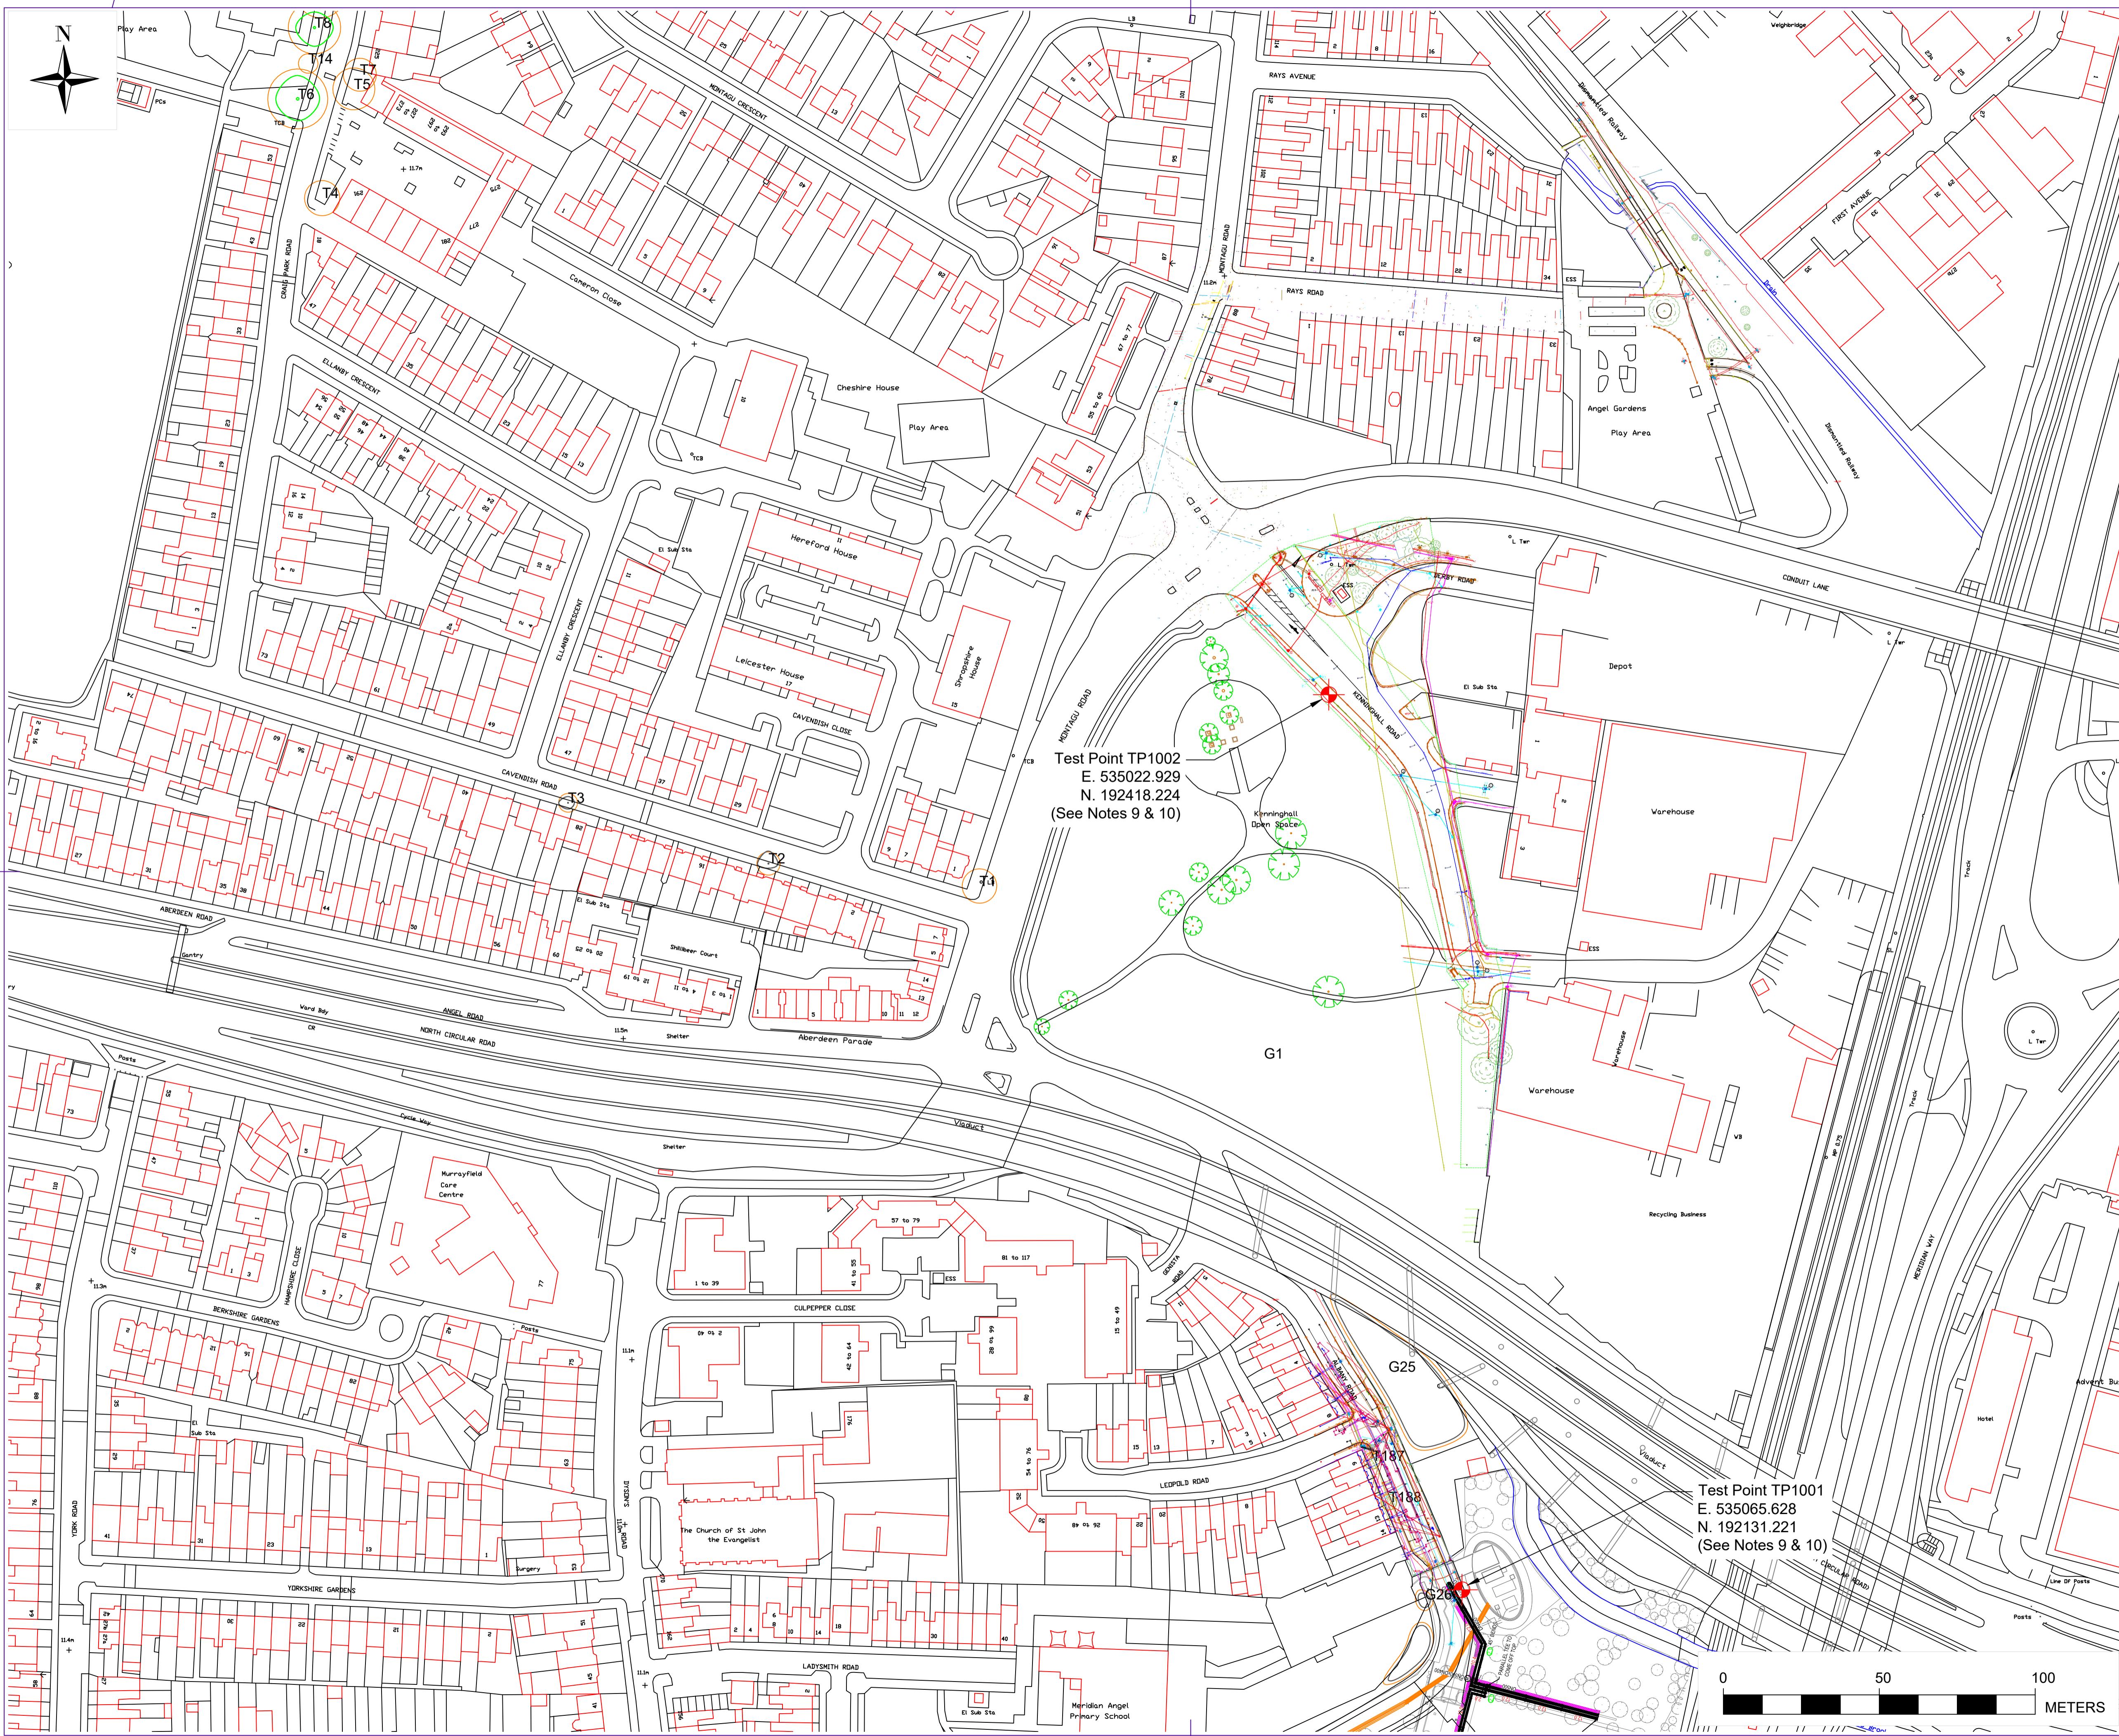

TP1005/TP1006 Top Of Cemetery Walkery Test Point Cabinet Location
Map Co-ordinates E. 534506.726 N. 193298.083
Map Co-ordinates E. 534492.869 N. 193304.361



TP1004 Cemetery Walk Test Point Cabinet Location
Map Co-ordinates E. 534748.252 N. 193006.977



TP1003 Angel Walk Test Point Cabinet Location
Map Co-ordinates E. 535019.241 N. 192690.581



TP1002 Kenninghall Road Test Point Cabinet Location
Map Co-ordinates E. 535022.929 N. 192418.224



TP1001 Albany Road/Meridian One Site Test Point Cabinet Location
Map Co-ordinates E. 535065.628 N. 192131.221



LEGEND

- Flow Pipe
- Return Pipe

NOTES

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2. All coordinates provided for the purpose of this work are based upon Ordnance Survey coordinates.
3. All levels are in metres (m) above Ordnance Datum.
4. Do not scale from this drawing, if in doubt, ask.
5. Assumptions made on site by contractors or sub-contractors are done so at their own risk.
6. This drawing should be read in combination with the Desktop study, GPR survey and the phase drawings linked to this one (continuation drawings).
7. Contractor to work around new and existing services. Any existing services/structures information that has been overlaid onto this drawing is for information purposes only and cannot be relied upon due to possible inaccuracies between background files, ground conditions, latest physical changes on site, etc. Prior to any work it is the contractors responsibility to ensure they have checked and verified the information along with working in accordance to industry standards, such as, but not limited to HSG 47 'Avoiding danger from Underground Services', etc.
8. It is the contractors responsibility to liaise with the utility companies in relation to working near/adjacent to their assets and seek any such approvals.
9. Above ground test point cabinets are to be Lucy Zodion Fortress Pillar Range. The type is a single door pillar - Size Code 08
Height (Above Ground) 836mm
Width 600mm
Depth 250mm
Colour Moss Green RAL 6005.

0 100 200 METERS

District Heating Pipe Network Design has been carried out in accordance with EN13941 - Parts 1 & 2, "Design & Installation of Thermal Insulated Bonded Single & Twin Pipe Systems for Directly Buried Hot Water Networks".

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| | | | | | |
|-----|--------------------------------------|----------|-------|--------|-------|
| C05 | For Construction | 24-04-18 | CH | | |
| C04 | For Construction | 24-03-27 | CH | | |
| C03 | For Construction - Test Points Added | 24-03-04 | CH | | |
| C02 | For Construction - Route Change | 24-02-27 | CH | | |
| C01 | For Construction | 23-06-15 | CH | | |
| REV | Description | Date | Appr. | Client | Appr. |


FOR CONSTRUCTION

 **PROVEN PROJECT CONSTRUCTION**
District Heating

 FVB District Energy UK Ltd
9 Greyfriars Road, Reading
RG1 1NU
United Kingdom
Email: info@fvb.uk.com

MERIDIAN WATER HEAT NETWORK
PLANNING GENERAL ARRANGEMENT
DH FLOW & RETURN
ZONE A1

| FVB Project No. | Drawn By | Scale A1 | Scale A3 | Status |
|-----------------|------------|----------|----------|--------|
| 22009 | CH | 1:3000 | 1:6000 | A |
| Project ID | Originator | Volume | Level | Type |

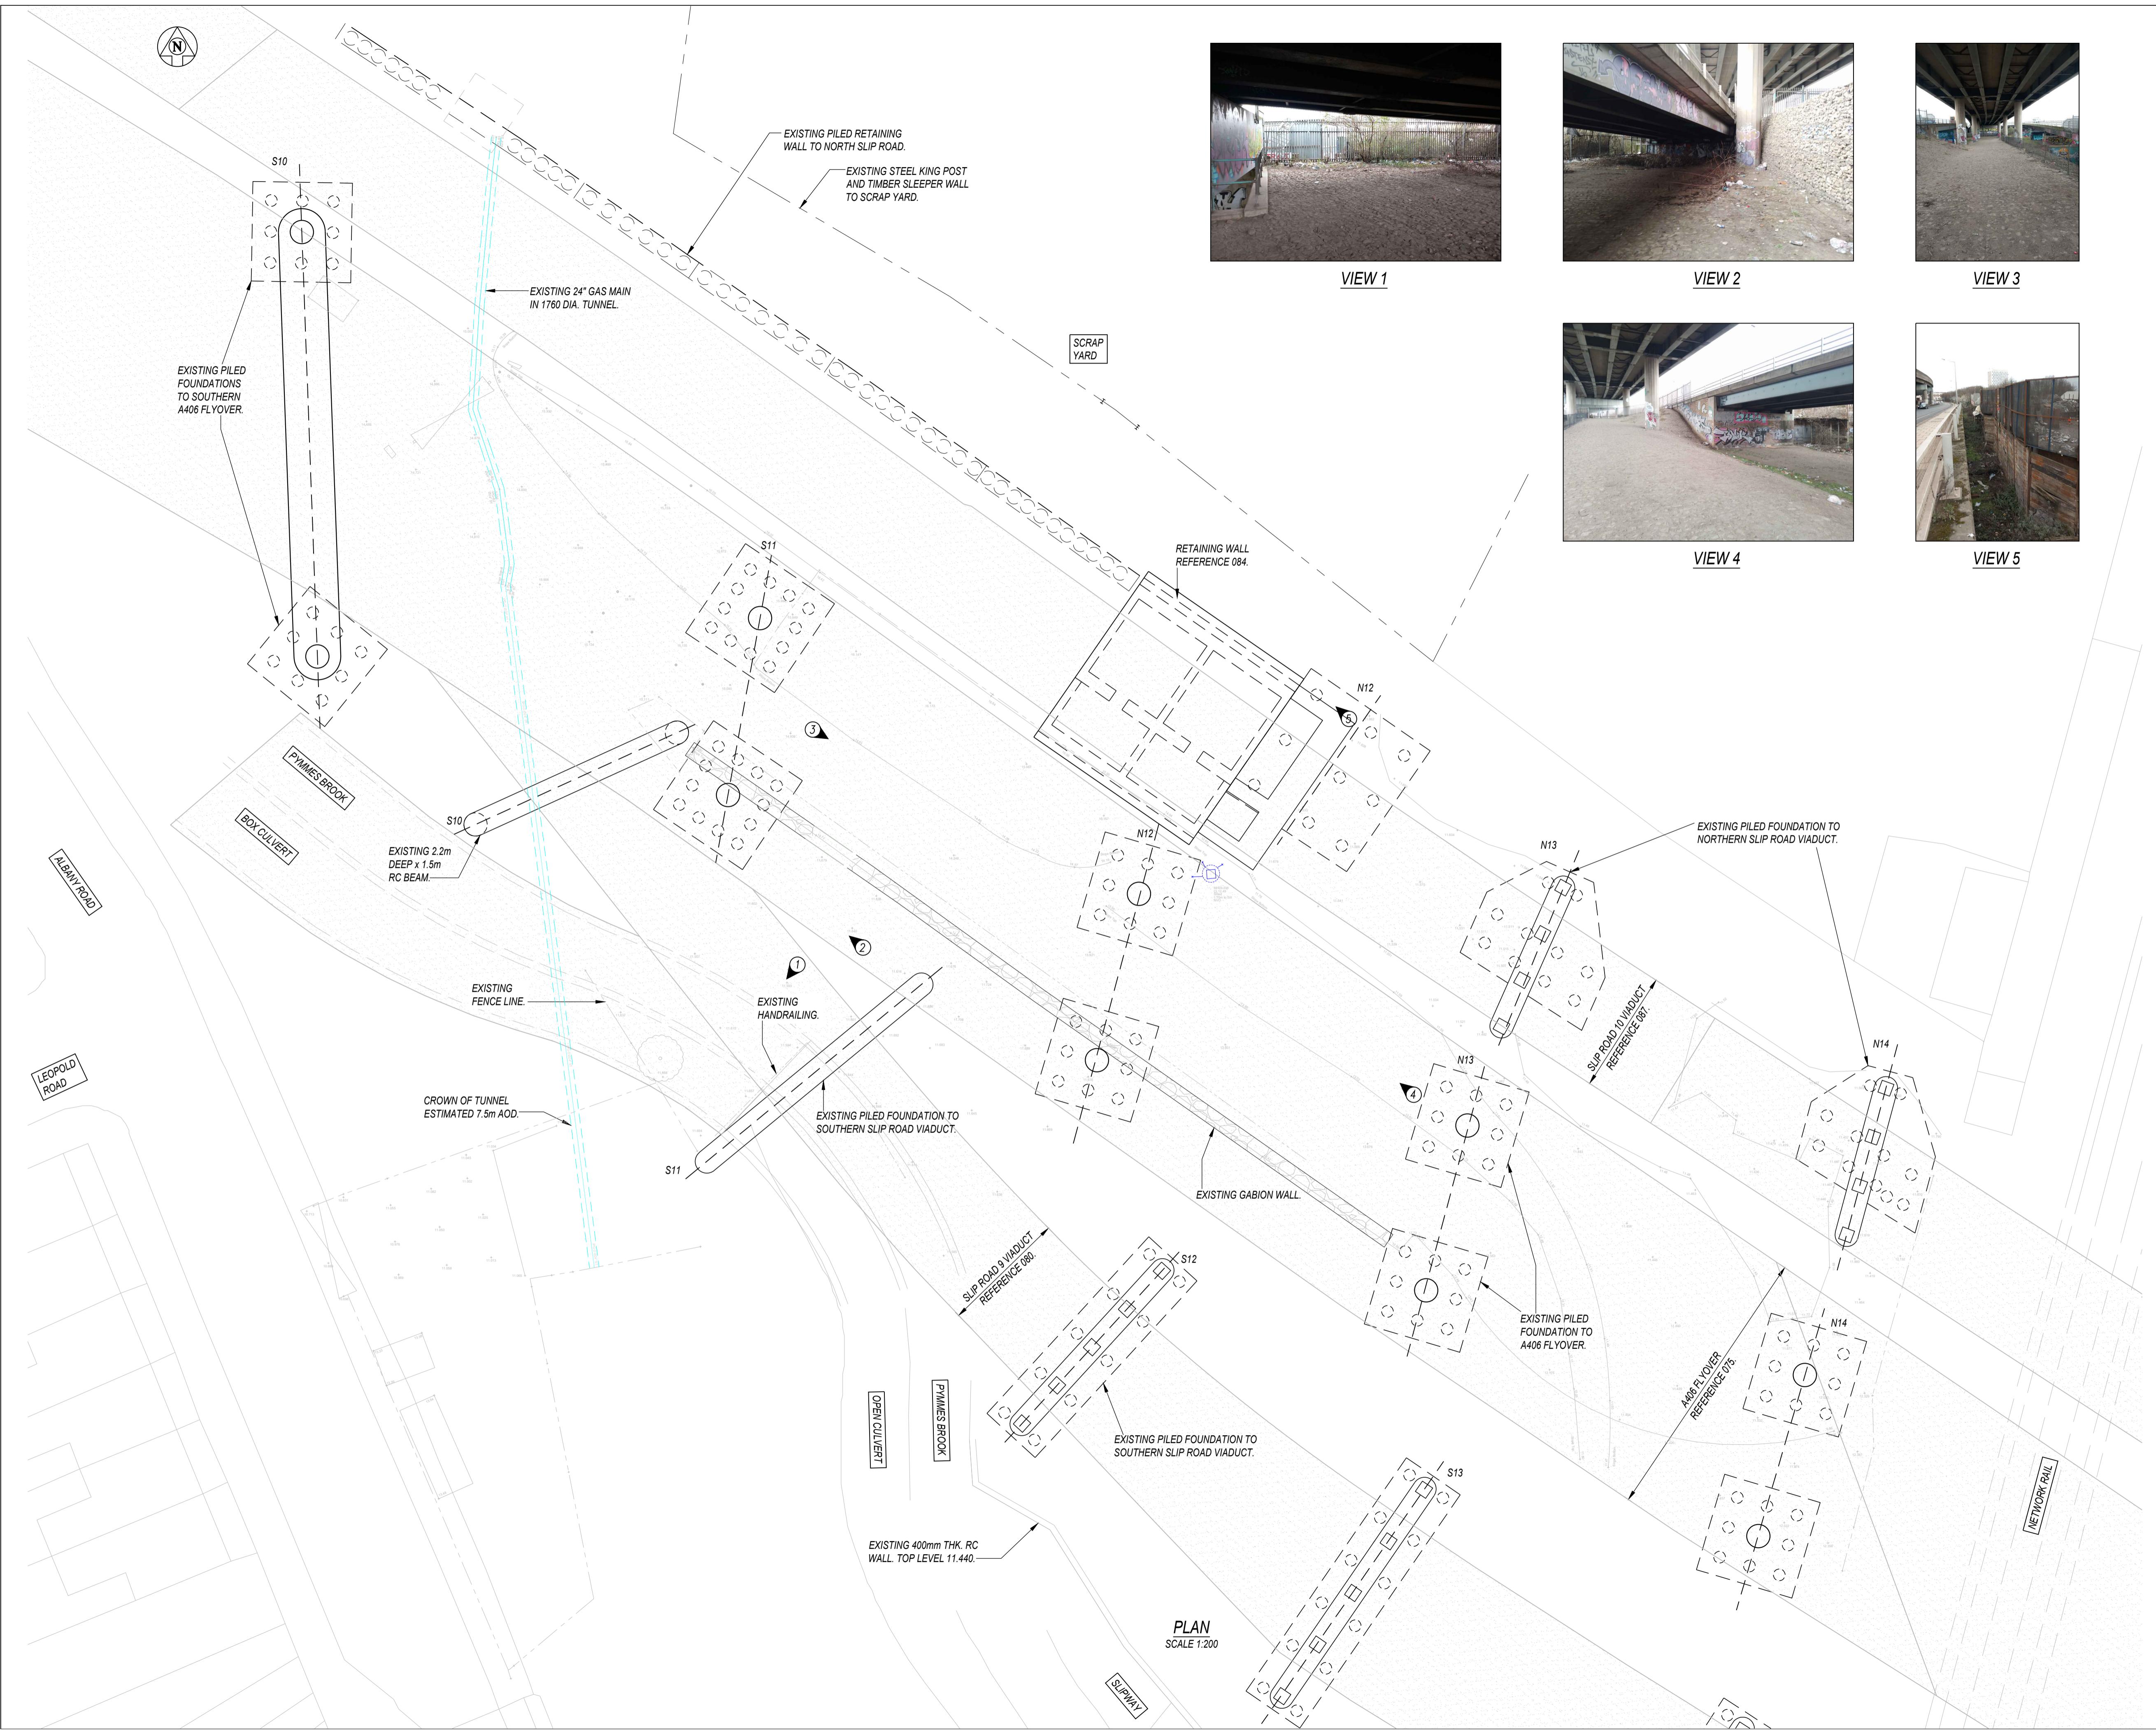

NOTES

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LOCATION PLAN NTS

COLOUR KEY EXISTING SERVICES

- EXISTING GAS MAIN (Blue line)
- EXISTING SURFACE WATER DRAINAGE (Red line)

COLOUR KEY

- +31.61 - EXISTING LEVEL
- (O) - DIRECTION OF PHOTO

| REV | DATE | BY | DESCRIPTION |
|-----|----------|-----|--|
| A03 | 13.03.24 | SSS | ALIGNMENT REVISED FOLLOWING TFL COMMENTS |
| A02 | 20.11.23 | SS | FOR AIP REVIEW |
| A01 | 08.09.23 | SS | FOR AIP REVIEW |
| P01 | 21.07.23 | SS | FOR INFORMATION |

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London Office
Highland House,
165 The Broadway,
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NW11 3BY
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E: info@veda.co.uk
www.veda.co.uk

CLIENT
 PROVEN PROJECT CONSTRUCTION
District Heating

PROJECT TITLE
MERIDIAN WATER A406 CROSSING

DRAWING TITLE
EXISTING SITE PLAN


DRAWING STATUS FOR AIP REVIEW

| | | | |
|-------------------|------------------------------|------------|-------|
| DRAWING NO. | 3605-VED-00-XX-DWG-CV-011000 | REV | A03 |
| DATE | JULY 2023 | SCALE @ A1 | 1:200 |
| DRAWN | SS | CHECKED | CPL |
| VEDA JOB NO. 3605 | | | |

| FOUNDATIONS | F_x (kN) | F_y (kN) | F_z (kN) | M_x (kNm) | M_y (kNm) | FOUNDATION TYPE |
|-------------|------------|------------|------------|-------------|-------------|-----------------|
| F1 | 0.00 | 5.97 | 89.05 | 0.00 | 10.15 | PILE |
| F2 | 0.00 | 6.90 | 102.83 | 0.00 | 11.72 | PILE |
| F3 | 0.00 | 3.07 | 27.90 | 0.00 | 3.38 | PAD |
| F4 | 0.00 | 3.71 | 37.75 | 0.00 | 4.18 | PAD |
| F5 | 0.00 | 2.81 | 25.50 | 0.00 | 3.51 | PAD |
| F6 | 0.00 | 2.39 | 21.75 | 0.00 | 2.99 | PAD |
| F7 | 9.45 | 0.00 | 73.80 | 0.00 | 23.63 | PILE |
| F8 | 16.70 | 0.00 | 139.38 | 0.00 | 41.74 | PILE |
| F9 | 11.47 | 0.00 | 89.54 | 0.00 | 28.67 | PILE |
| F10 | 7.37 | 0.00 | 35.10 | 0.00 | 12.16 | PAD |
| F11 | 6.30 | 0.00 | 30.00 | 0.00 | 10.40 | PAD |
| F12 | 6.30 | 0.00 | 30.00 | 0.00 | 10.40 | PAD |
| F13 | 6.30 | 0.00 | 30.00 | 0.00 | 10.40 | PAD |
| F14 | 6.30 | 0.00 | 30.00 | 0.00 | 10.40 | PAD |
| F15 | 6.30 | 0.00 | 30.00 | 0.00 | 10.40 | PAD |
| F16 | 6.30 | 0.00 | 30.00 | 0.00 | 10.40 | PAD |
| F17 | 6.30 | 0.00 | 30.00 | 0.00 | 10.40 | PAD |
| F18 | 6.30 | 0.00 | 30.00 | 0.00 | 10.40 | PAD |
| F19 | 6.30 | 0.00 | 30.00 | 0.00 | 10.40 | PAD |

NOTE:


1. F_x IS PERPENDICULAR TO THE PIPE RUN.
2. F_y IS LONGITUDINAL TO THE PIPE RUN.
3. F_z IS THE VERTICAL REACTION TO THE FOUNDATION.
4. PIPE SW IS CONSIDERED AT FULL CAPACITY LOAD ANY OTHER LOAD TRANSFERRED TO THE SUPPORT DUE TO CHANGE OF TEMPERATURE OF THE PIPE AND/OR PRESSURE OF WATER, ETC HAVE NOT BEEN CONFIRMED.
5. AT THE AIP STAGE, PIPE DESIGNER TO CONFIRM THESE LOADINGS AT THE DETAILED DESIGN STAGE.
6. WIND LOADING ON THE MOST ENORMOUS DIRECTION 20% OF THE PIPE SW ADDED TO CONSIDERED THE ADDITIONAL STEELWORK REQUIRED TO SUPPORT THE PIPES.
7. ADDITIONAL STEEL BEAM LOADINGS TAKING INTO ACCOUNT

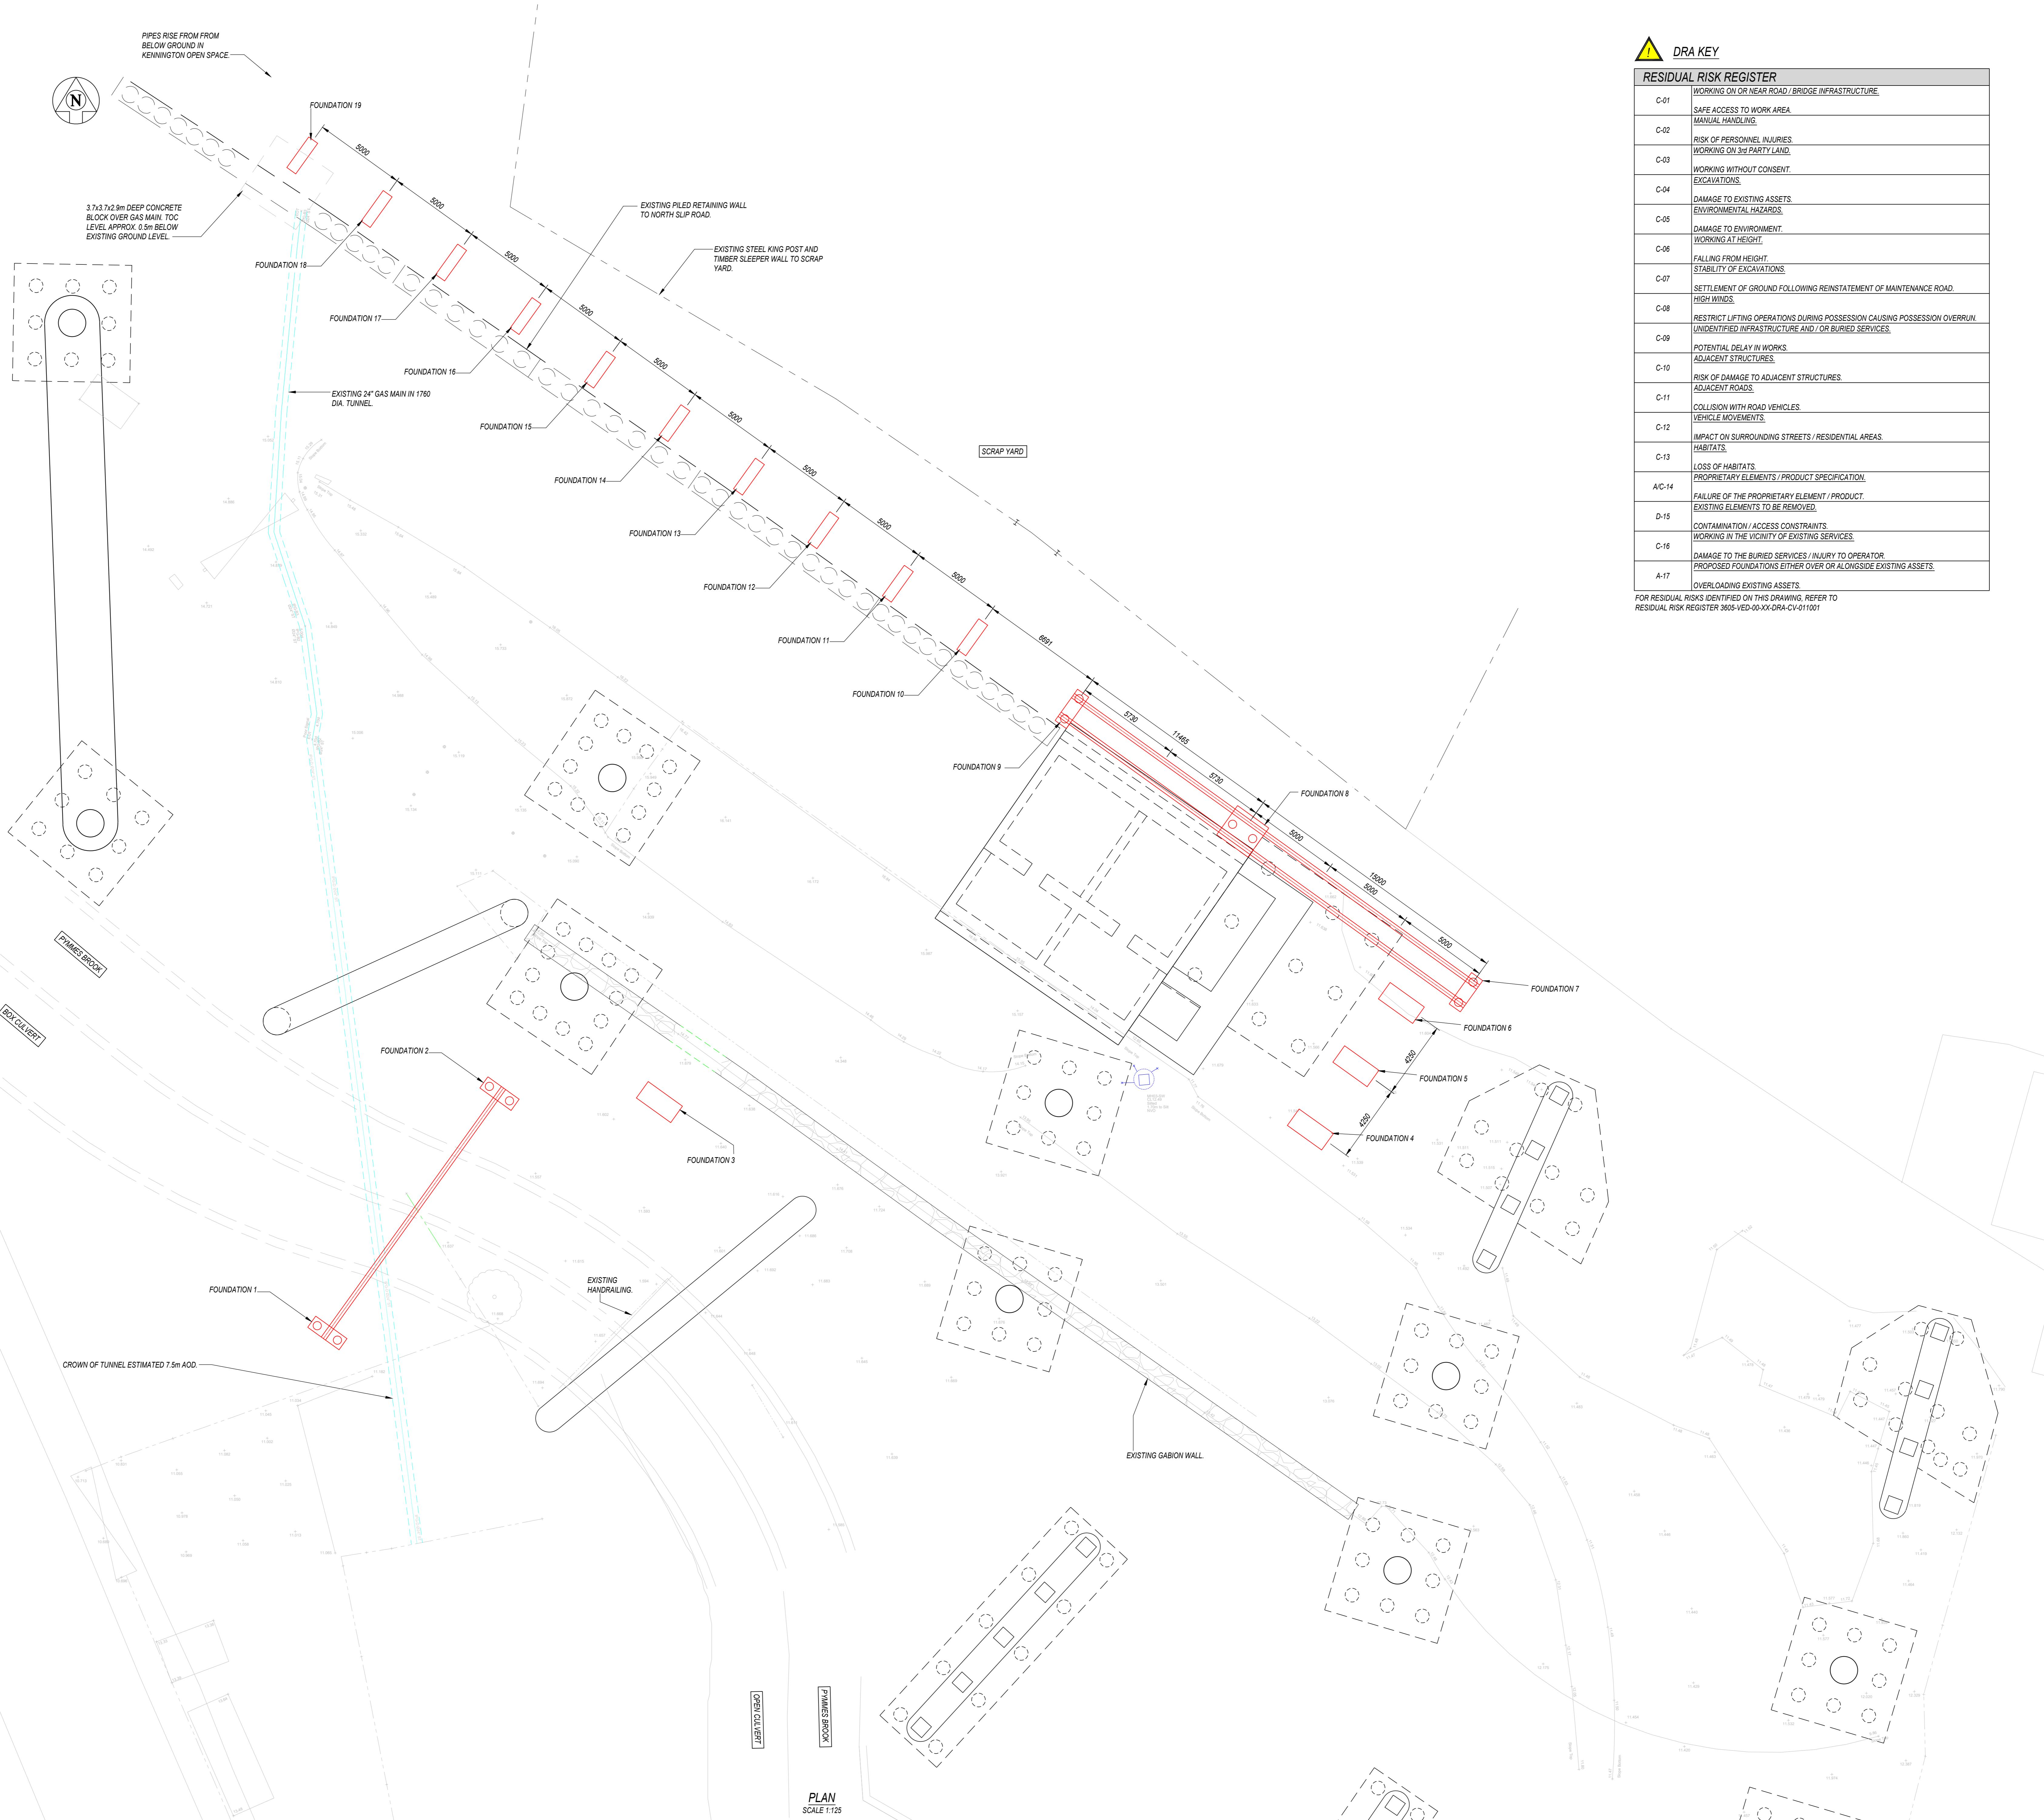

NOTES

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| | | | |
|---|-------------|--------------|--|
| A01 | 13.03.2024 | SSS | ALIGNMENT REVISED FOLLOWING TfL COMMENTS |
| REV | DATE | BY | DESCRIPTION |
| VEDA | | | |
| London Office, Highland House, 100 Kingsway, London, WC1X 9HT Tel: 020 7242 5017 E: info@veda.co.uk www.veda.co.uk | | | |
| CLIENT PROVEN PROJECT CONSTRUCTION District Heating | | | |
| PROJECT TITLE MERIDIAN WATER A406 CROSSING | | | |
| DRAWING TITLE REACTION AT EACH SUPPORT | | | |
| DRAWING STATUS FOR AIP REVIEW | | | |
| DRAWING NO. 3605-VED-00-XX-DWG-CV-01003 REV A01 | | | |
| DATE | MARCH 2023 | SCALE @ A1 | AS SHOWN |
| DRAWN SS | CHECKED CPL | VEDA JOB NO. | 3605 |

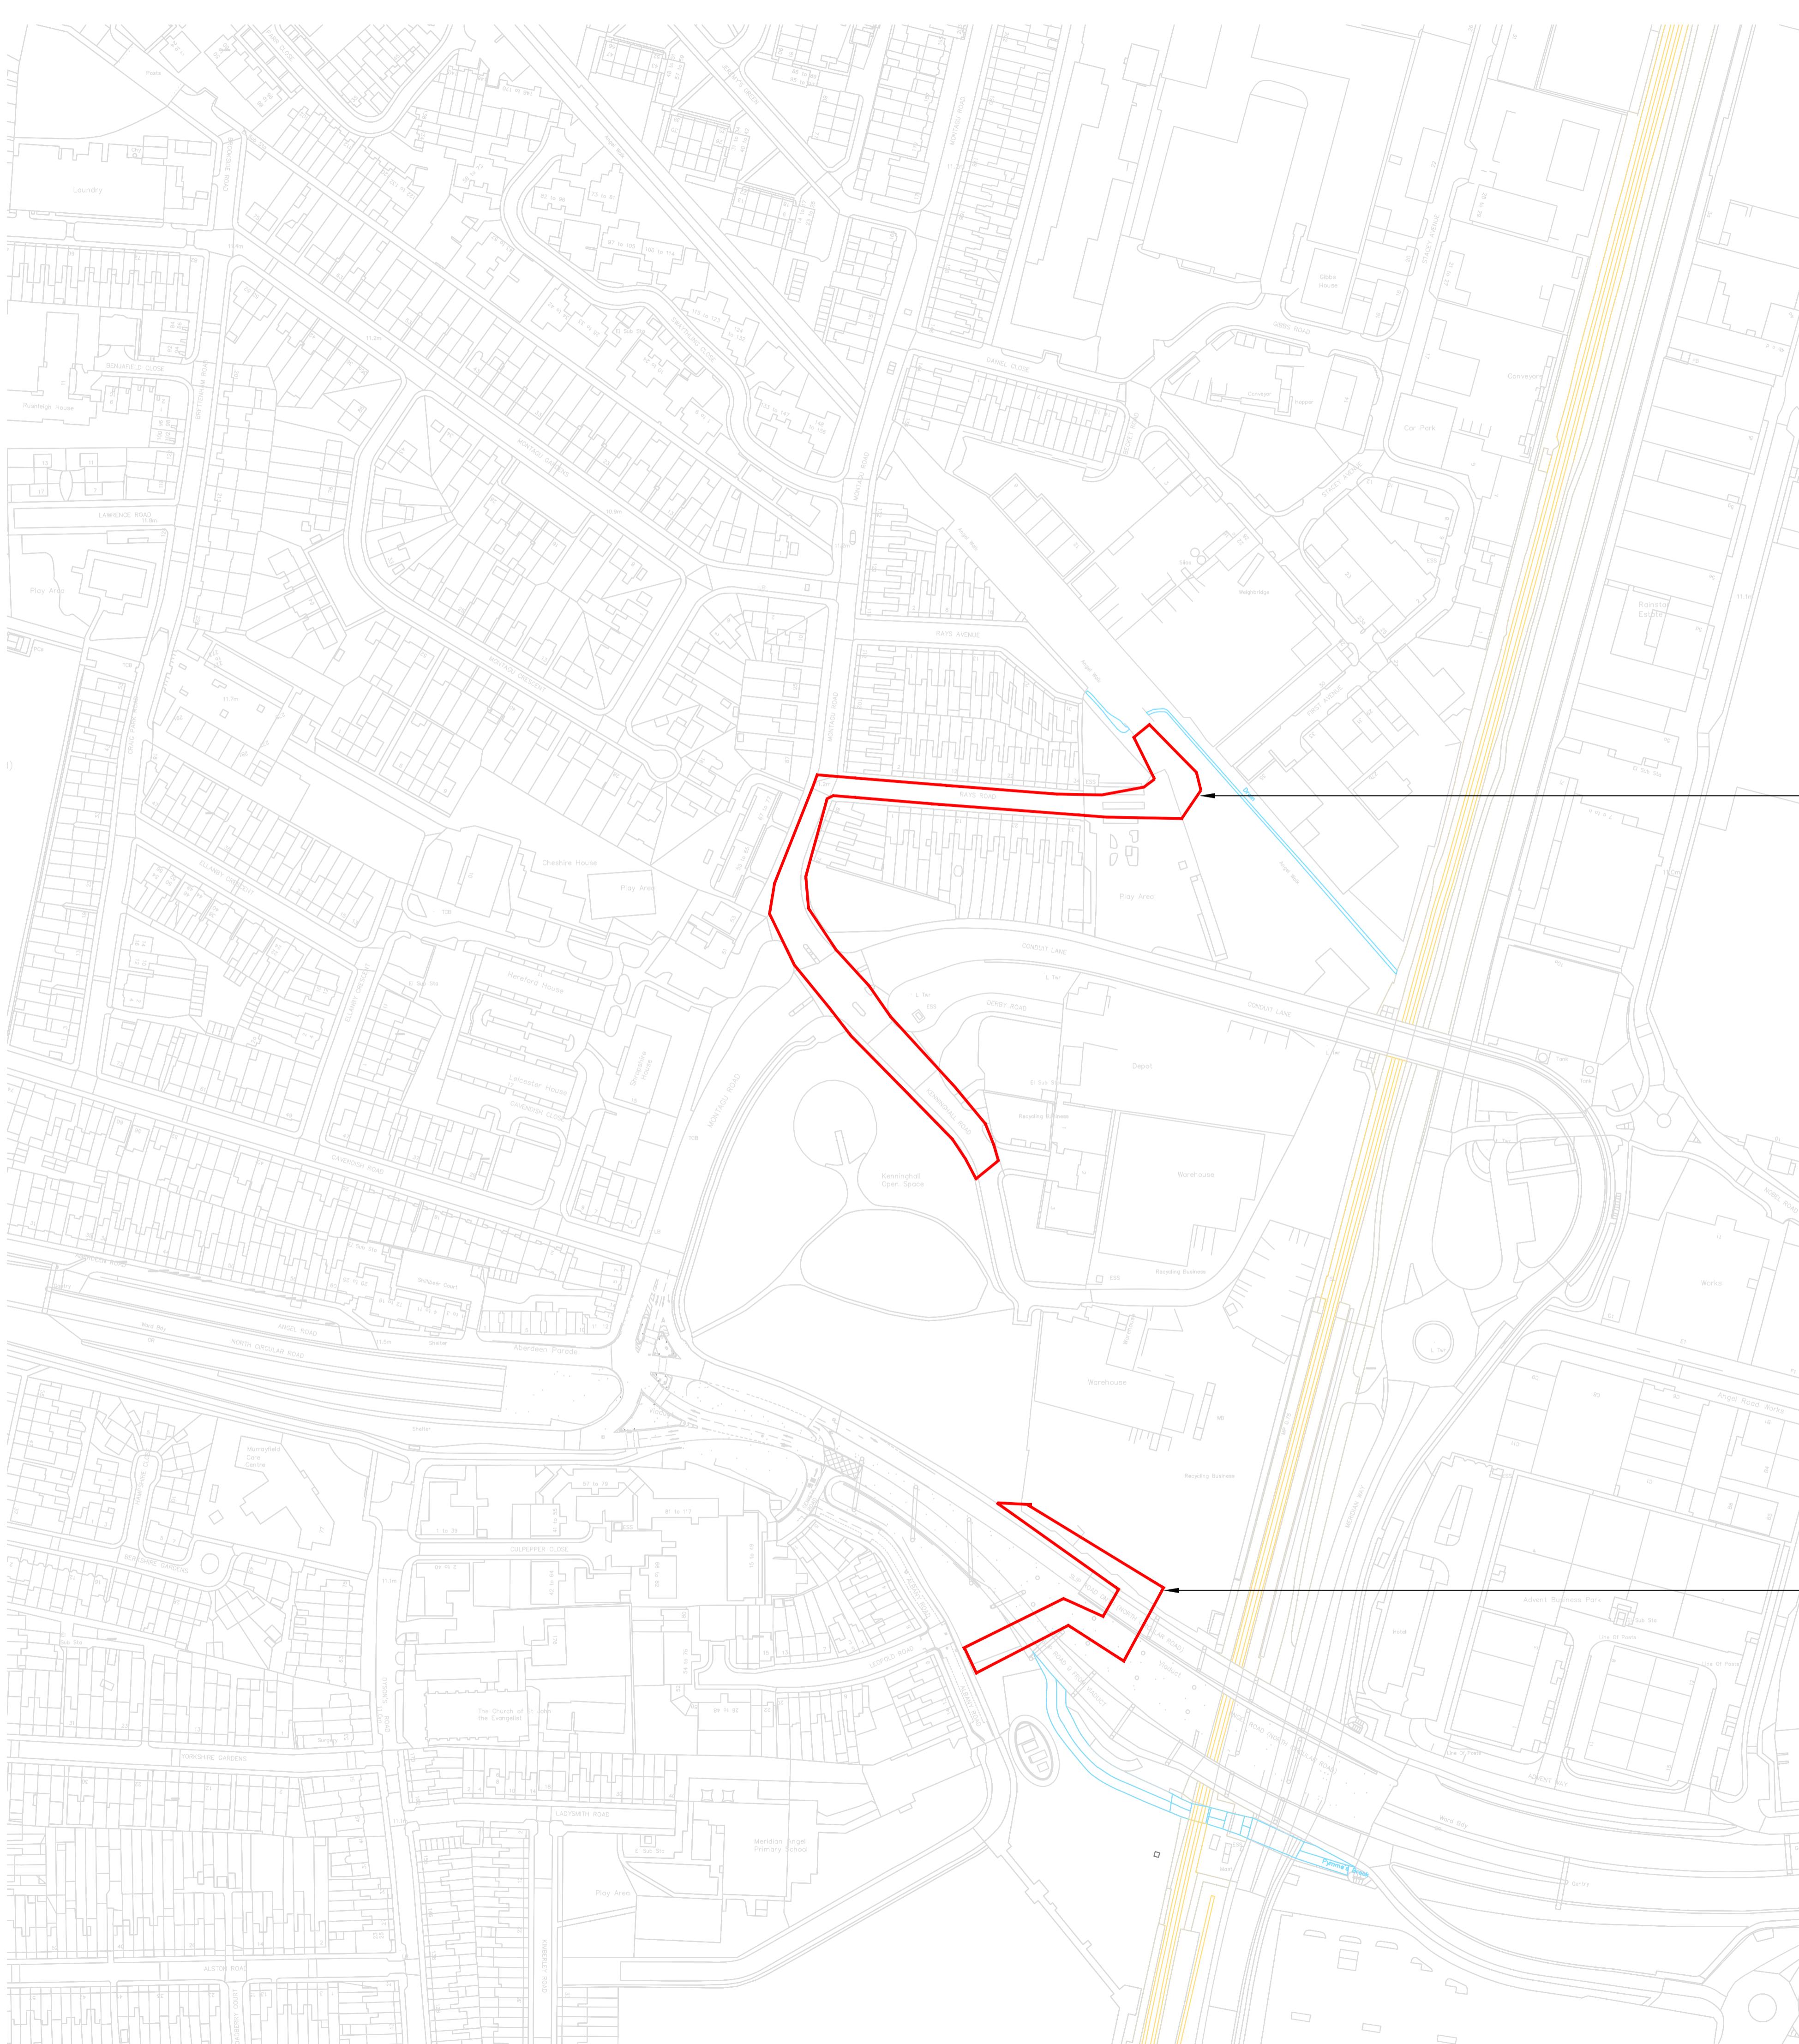

PHASE 1 REVISED ROUTE
RED LINE BOUNDARY

PHASE 1 REVISED ROUTE
RED LINE BOUNDARY

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O1 FIRST ISSUE FOR INFORMATION AL PH 17.04.24
REV DESCRIPTION ISSUED CHECKED DATE

PURPOSE OF ISSUE
ISSUE FOR INFORMATION

PROJECT INFORMATION
ENFIELD DISTRICT HEATING NETWORK
CLIENT


energetik

DRAWING INFORMATION
REVISED RED LINE BOUNDARY

DRAWING NO.
1665-ENF-D3A-00-XX-DR-M-0058

PROJECT NO. DRAWN SCALE @ A1 STATUS REVISION
1665 AL 1 : 1500 S2 R01

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- CHECK ALL DIMENSIONS ON SITE
- TO BE READ IN CONJUNCTION WITH HEALTH AND SAFETY PLAN
AND ALL RELEVANT RISK ASSESSMENTS

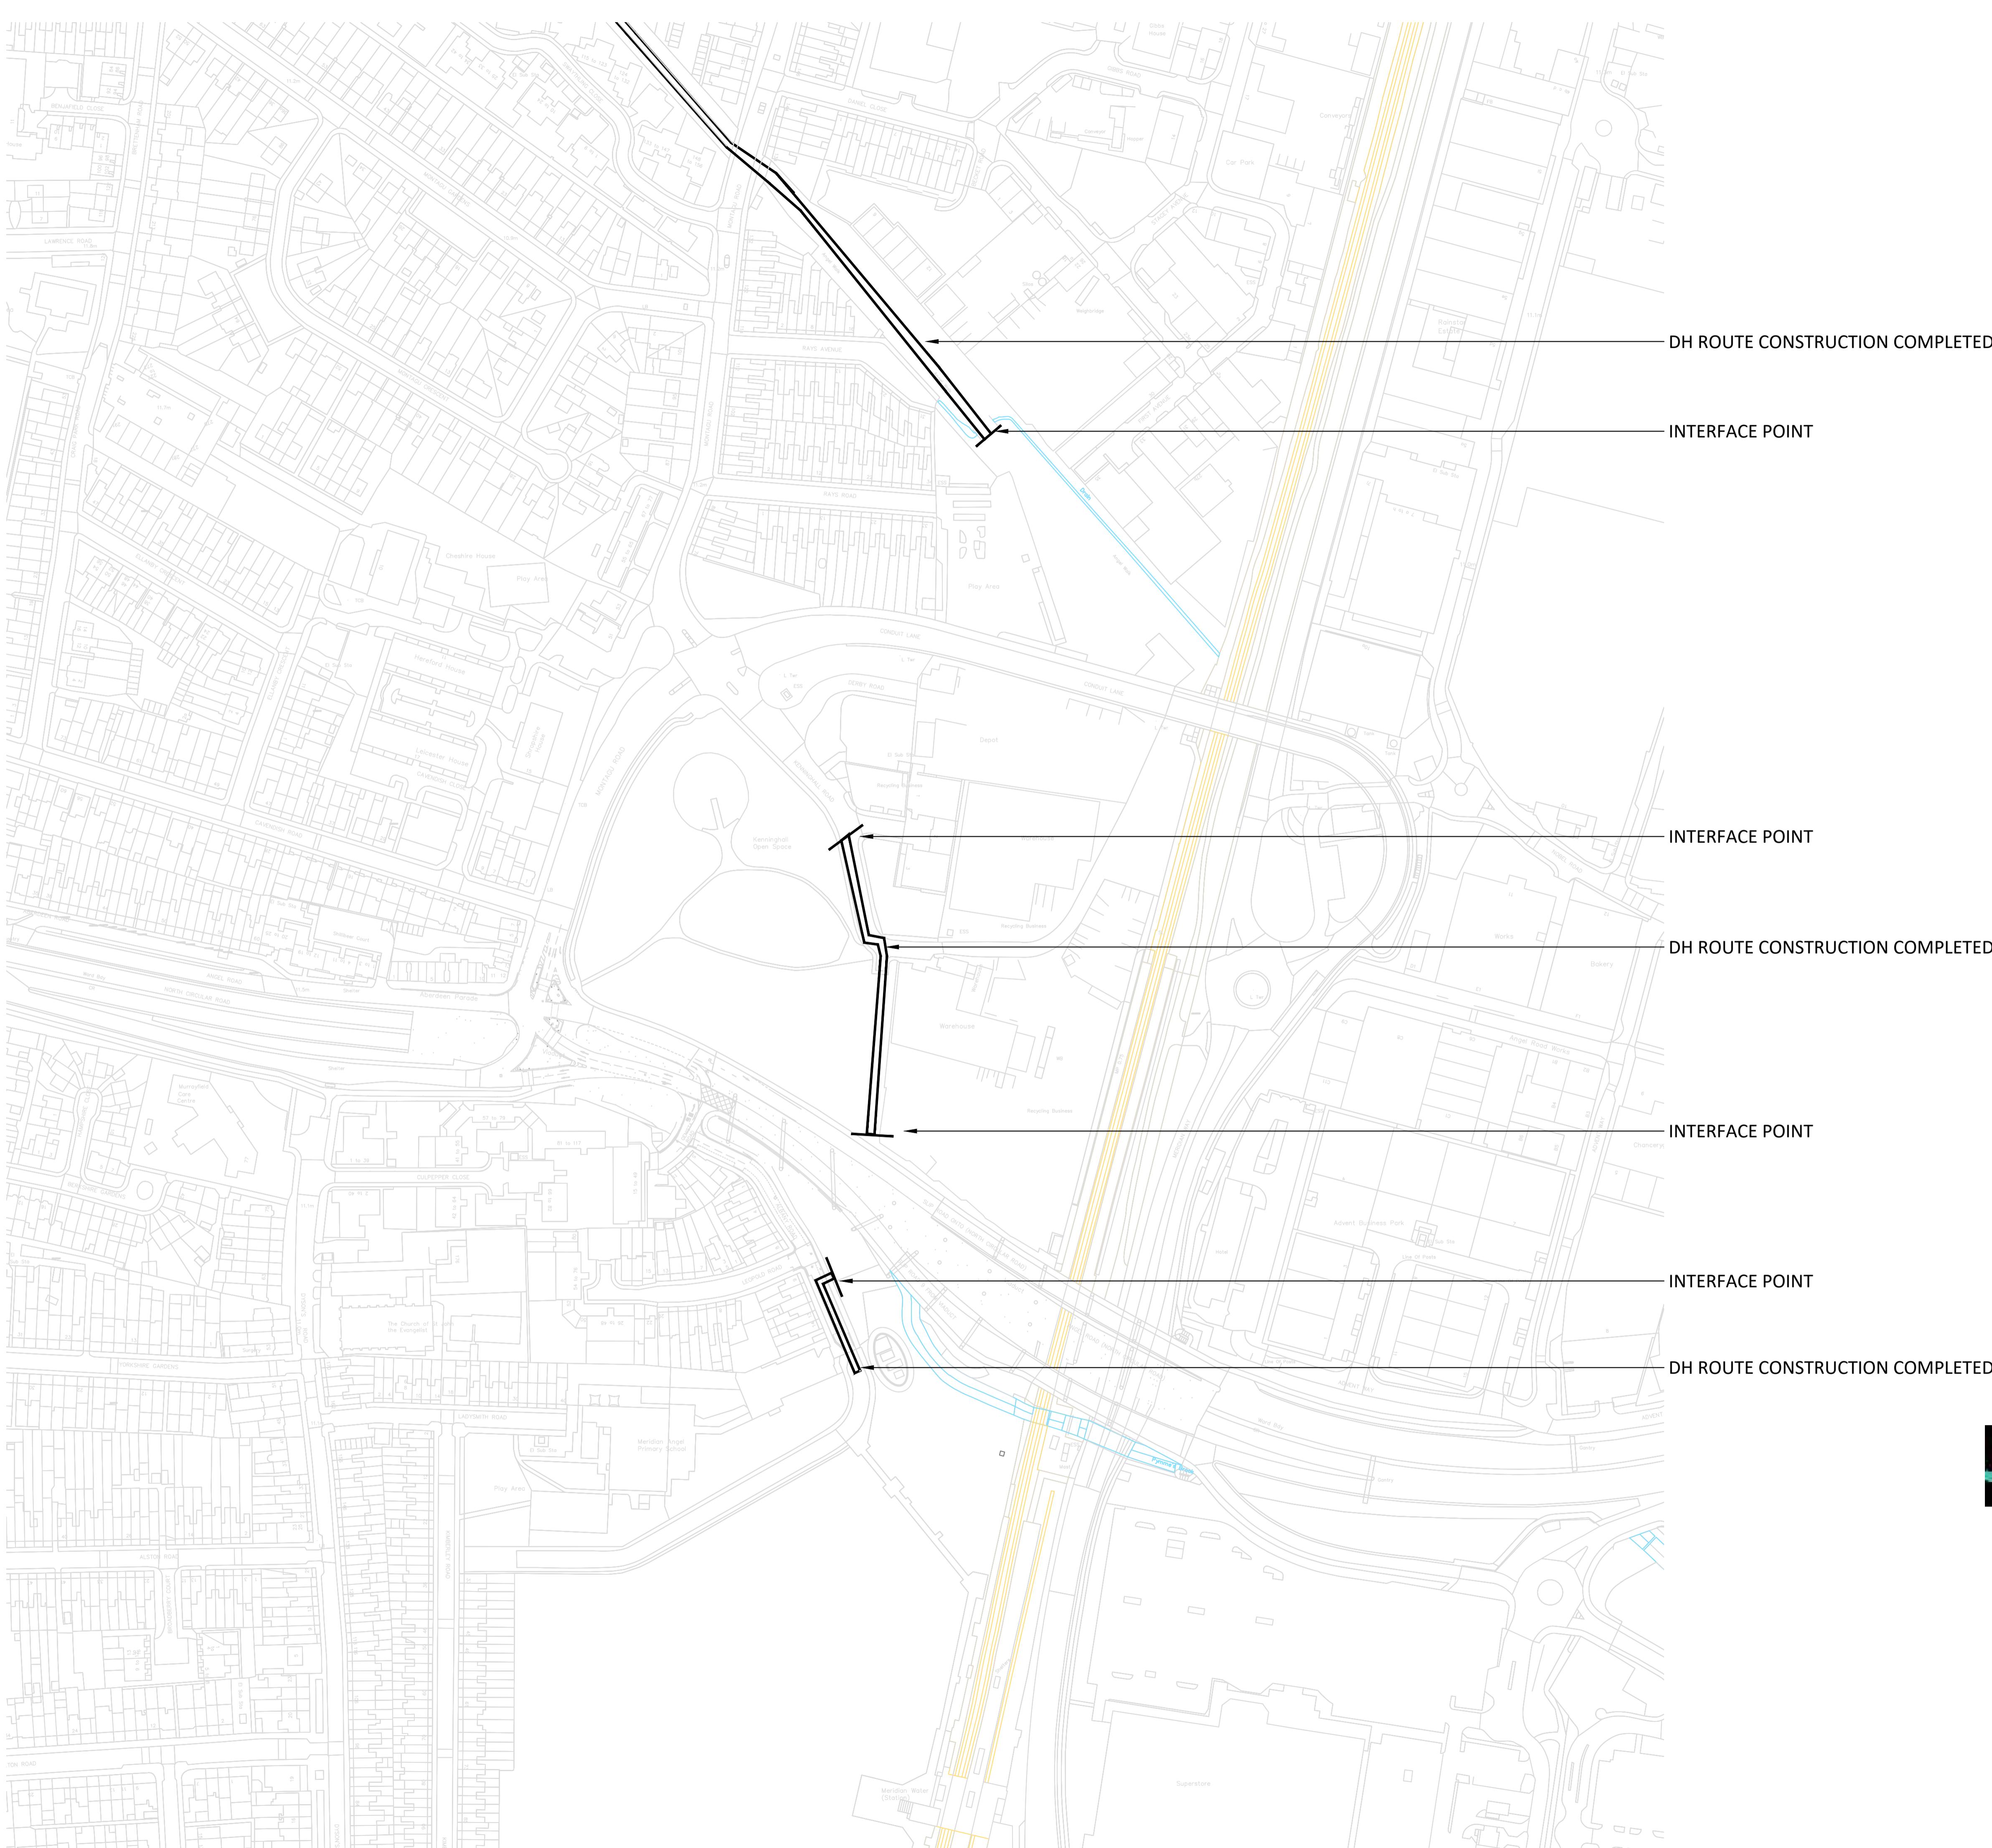

O1 FIRST ISSUE FOR INFORMATION AL PH 17.04.24
REV DESCRIPTION ISSUED CHECKED DATE

PURPOSE OF ISSUE
ISSUE FOR INFORMATION

PROJECT INFORMATION
ENFIELD DISTRICT HEATING NETWORK
CLIENT

energetik

DRAWING INFORMATION
POINTS OF INTERSECTION

DRAWING NO.
1665-ENF-D3A-00-XX-DR-M-0059

PROJECT NO. DRAWN SCALE @ A1 STATUS REVISION
1665 AL 1 : 1500 S2 R01

DISTRICT HEATING NETWORK LEGEND
FOR ADDITIONAL TECHNICAL INFORMATION PLEASE REFER
TO THE FOLLOWING MANUALS
1. DESIGN MANUALS
2. DESIGN WITH TWIN PIPES
3. PRODUCT CATALOGUE
4. SURVEILLANCE MANUAL
5. HANDLING AND INSTALLATION

PIPEWORK
 FLOW
 RETURN
 PIPE LENGTH INDICATION AND
JOINT POSITION
 DN400/710OD
 NOMINAL PIPE SIZE AND
OUTSIDE
DIAMETER OF CASING PIPE
 PREINSULATED REDUCTION
 POSITION OF PIPE ANCHORS
 AV - AIR VENT
 DP - DRAIN POINT

DIRECTION CHANGES
 PREINSULATED BEND
WITH APPROX. ANGLE
 PREINSULATED CURVED PIPE
WITH TBC

BRANCHES
 BRANCH
 MAIN
 PREINSULATED PARALLEL T-PIECE
90° BRANCH OFF TOP OF MAIN
 BRANCH
 MAIN
 PREINSULATED T-PIECE 90°
BRANCH OFF TOP OF MAIN
 BRANCH
 MAIN
 PREINSULATED T-PIECE 45°
BRANCH OFF TOP OF MAIN

VALVES
 V/D
 V/D
 V/D
 V/D
 V/D
 V/D
 GENERAL
 CHAMAGE

UTILITIES LEGEND
 ELECTRICITY CABLE AND/OR PILOT CABLE
 GAS PIPE
 BRITISH TELECOM CABLE
 VIRGIN MEDIA TELEVISION CABLE
 WATER PIPE
 DRAINAGE PIPE
 COMMUNICATION CABLE
 COMPRESSED AIR
 ABANDONED / DECOMMISSIONED UTILITY
(ABBREVIATION INDICATES UTILITY TYPE)
 ASSUMED ROUTE OF OVERHEAD
TELECOMMUNICATIONS CABLE
(FROM UTILITY RECORD)
 BOUNDARY OF COORDINATED UTILITY
DRAWING
 QUALITY LEVEL ACHIEVED
(See PAS-128 Levels table)
 DIAMETER OF PIPE
 SUBSTATION AREA HIGHLIGHT
 INLAND WATER
 RAILWAY TRACK / TRAMLINE

COMPOSITE KEY
 WATER ASSETS
 BRITISH TELECOM ASSETS
 GAS ASSETS
 ELECTRIC ASSETS
 COMMUNICATION / CABLE TV ASSETS
 OTHER

These are generic symbols used by Catavus and they differ from the actual assets used on each utility provider drawing. Please refer to individual utility type.

| *QUALITY LEVELS (BSI PAS-128) | | Confidence Level |
|---|--|--|
| Quality Level Achieved | Method of Detection | |
| (A) | Verification by Excavation, Manhole / Inspection Chamber entry | Horizontal Vertical |
| (B1) | Detected by Multiple Geophysical Techniques (EM, GPR, TDR) | ±50mm ±25mm |
| (B2) | Detected by One Geophysical Technique (EM, or GPR) | ±150mm or ±15% of depth ±250mm or ±40% of depth |
| (B3) | Geophysical Techniques Unsuccessful. Not Detected (Assumed Route) | ±500mm Undefined |
| (B4) | Geophysical Techniques Unsuccessful. Not Detected (Assumed Route) | Undefined Undefined |
| (C) | Survey of Existing Street Furniture / Survey / Topographic Features Detected | Undefined Undefined |
| (D) | Desktop Utility Record Search Data | Defined Defined |
| The letter (P) after levels B1, B2 & B3 to indicate that off-site post processing of GPR has been included. | | |

The information provided on this drawing about the existing utility infrastructure is based on historic records provided by the statutory undertakers and therefore should be treated as a starting point only.

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KEY [This drawing must be reproduced in colour]

Tree Quality Categorisation
(Based on BS 5837:2012 Trees in relation to design, demolition and construction - Recommendations)

T1/1 Trees
 H1 Hedgerow
 Root Protection Area (RPA)
 Category A (high quality)
 Category B (moderate quality)
 Category C (low quality)
 Category U (unusable for retention)
 Hedgerow (not categorised)

NOTES:

This drawing should be read in conjunction with the respective Arboricultural Survey Data

The majority of trees were not recorded on the topographical survey provided. Where this was the case, tree locations have been approximated using a combination of aerial imagery and on-site observations

001 TENDER ISSUE 10.12.21 PH 10.12.21

Rev Description Issued Checked Date

Purpose of issue

TENDER

Project Information

Client:

energetik

Title: Enfield District Heating Network

Drawing Information


District Heating Network
Phase 1 Layout 1 of 38


Project ID Originator Zone Level Type Role Drawing No.
ENF D3A 00 XX DR M 0011

Project No. Drawn Scale @ As Status Revision

1665 DW 1:200 D2 001

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DISTRICT HEATING NETWORK LEGEND

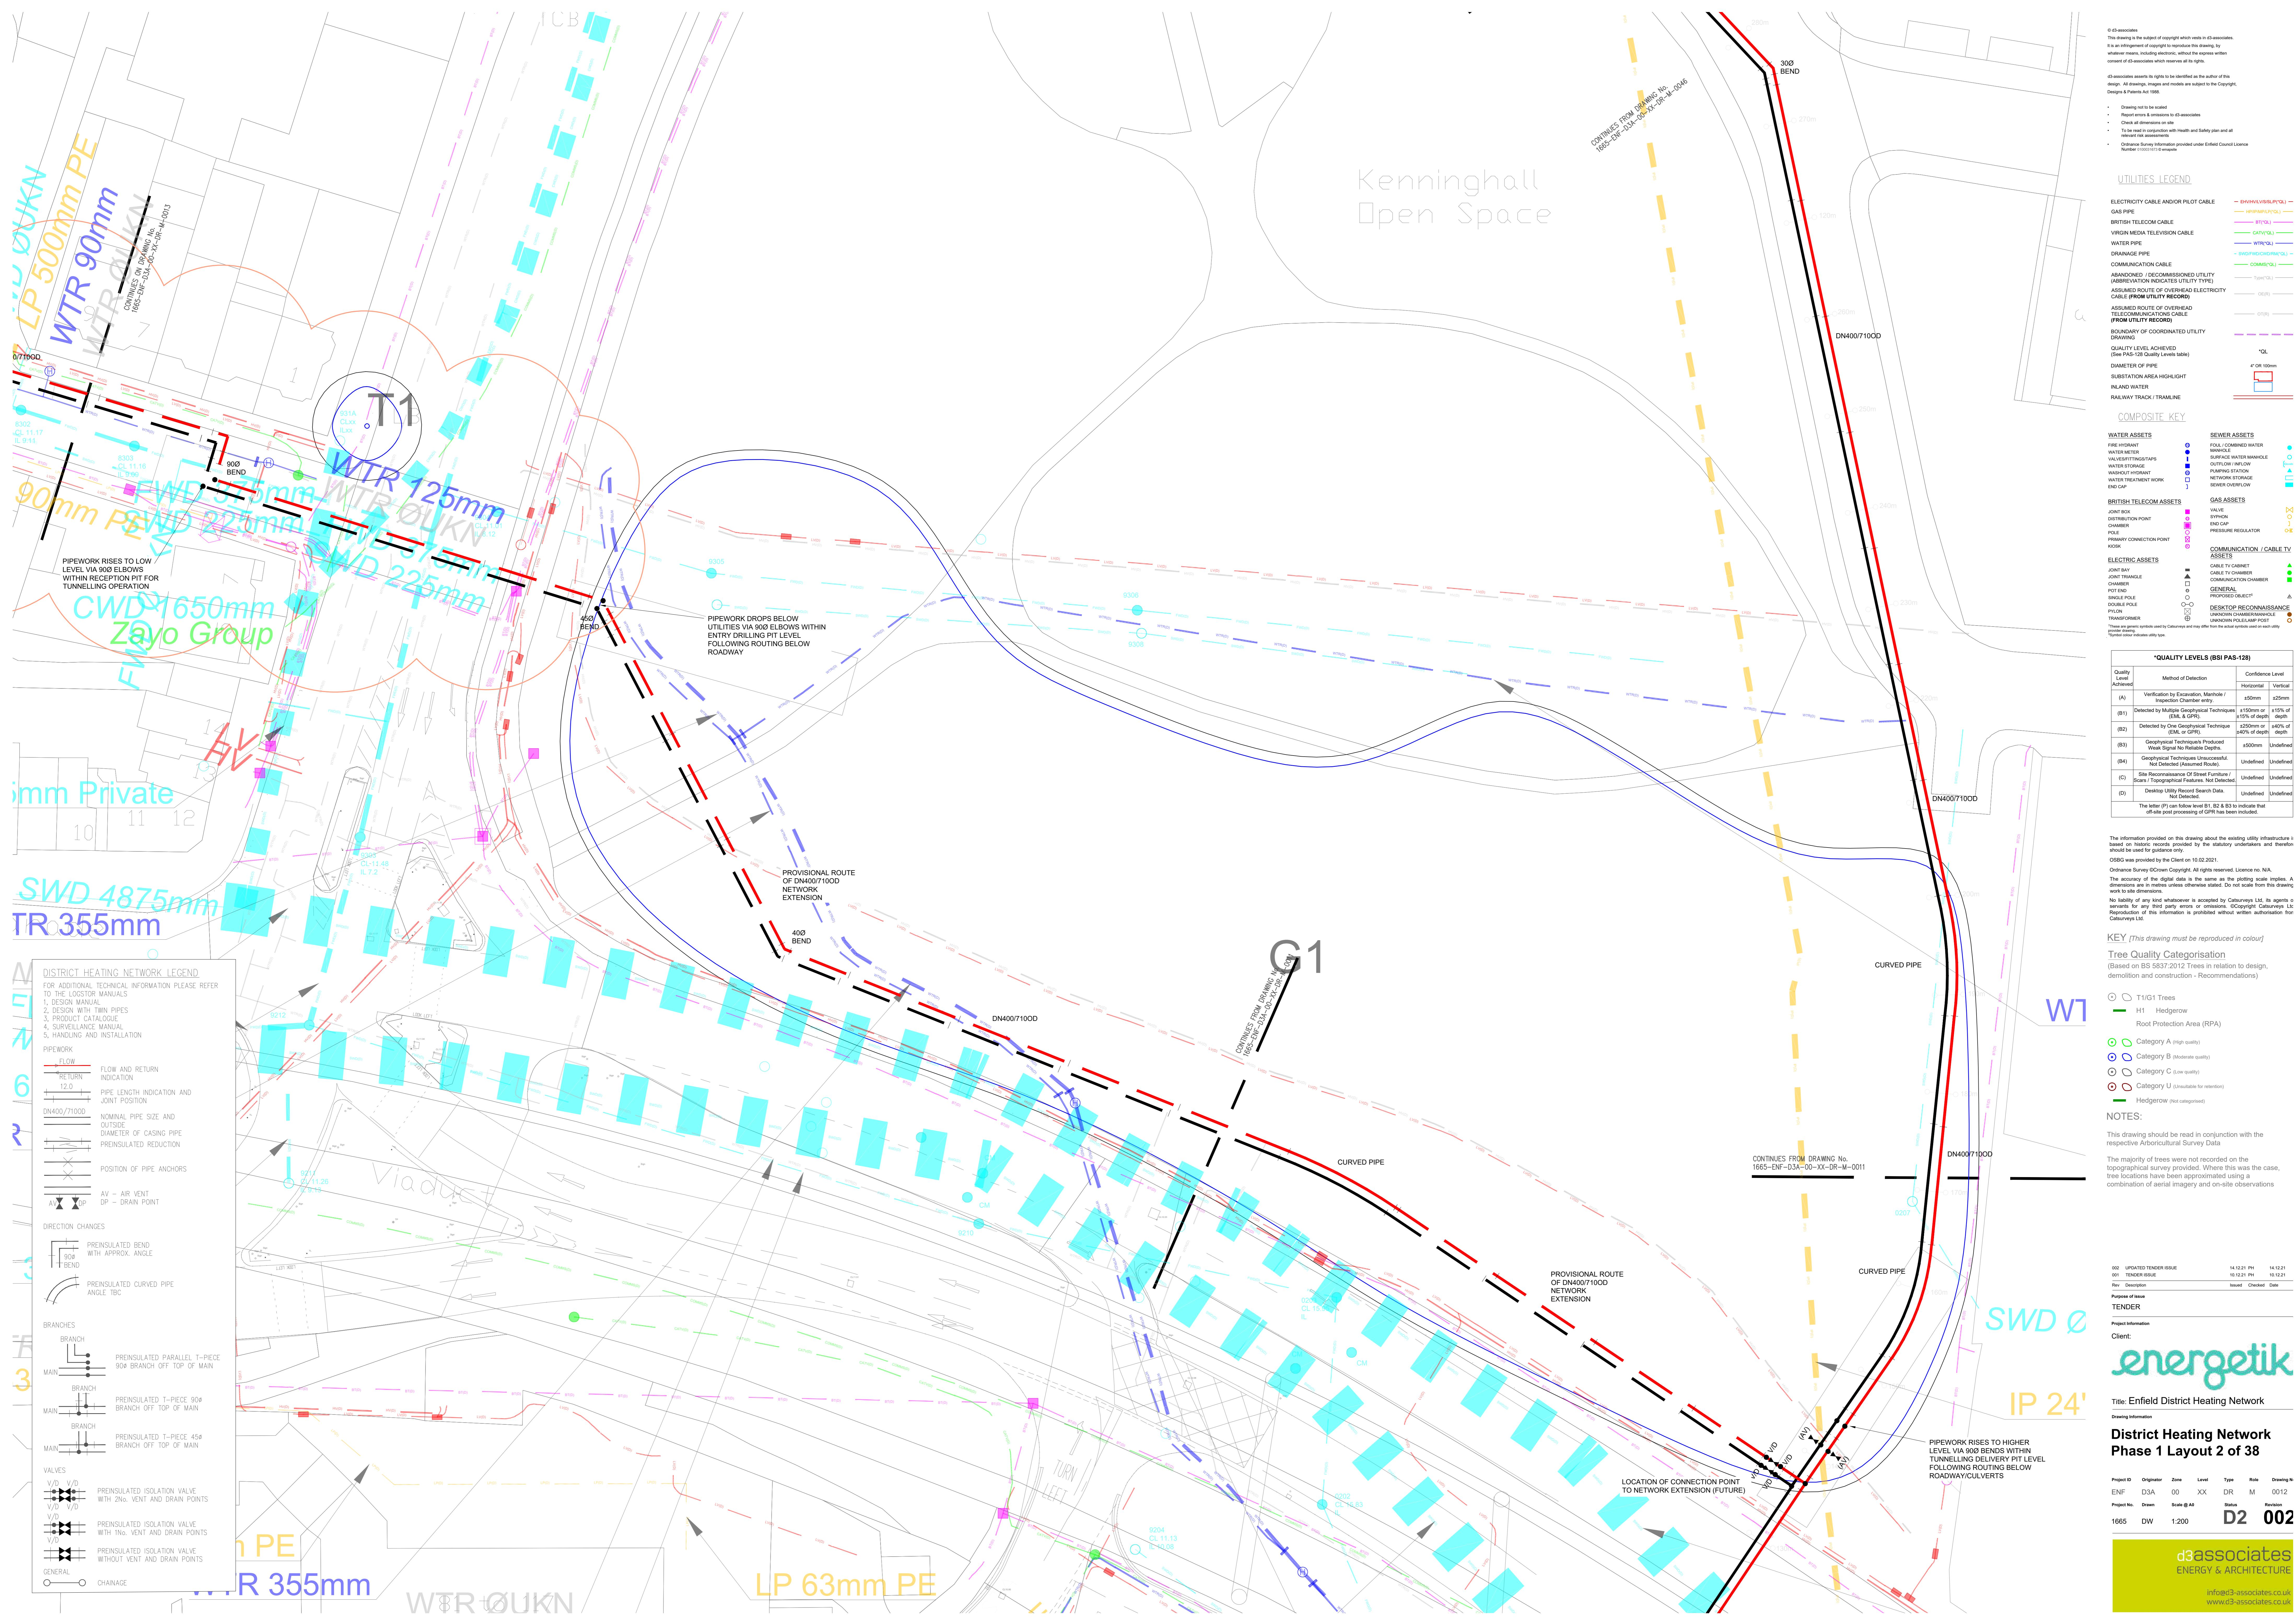FOR ADDITIONAL TECHNICAL INFORMATION PLEASE REFER
TO THE LOGSTOR MANUALS
1. DESIGN MANUAL
2. DESIGN WITH TWIN PIPES
3. PROVISIONAL ROUTE
4. SURVEILLANCE MANUAL
5. HANDLING AND INSTALLATION

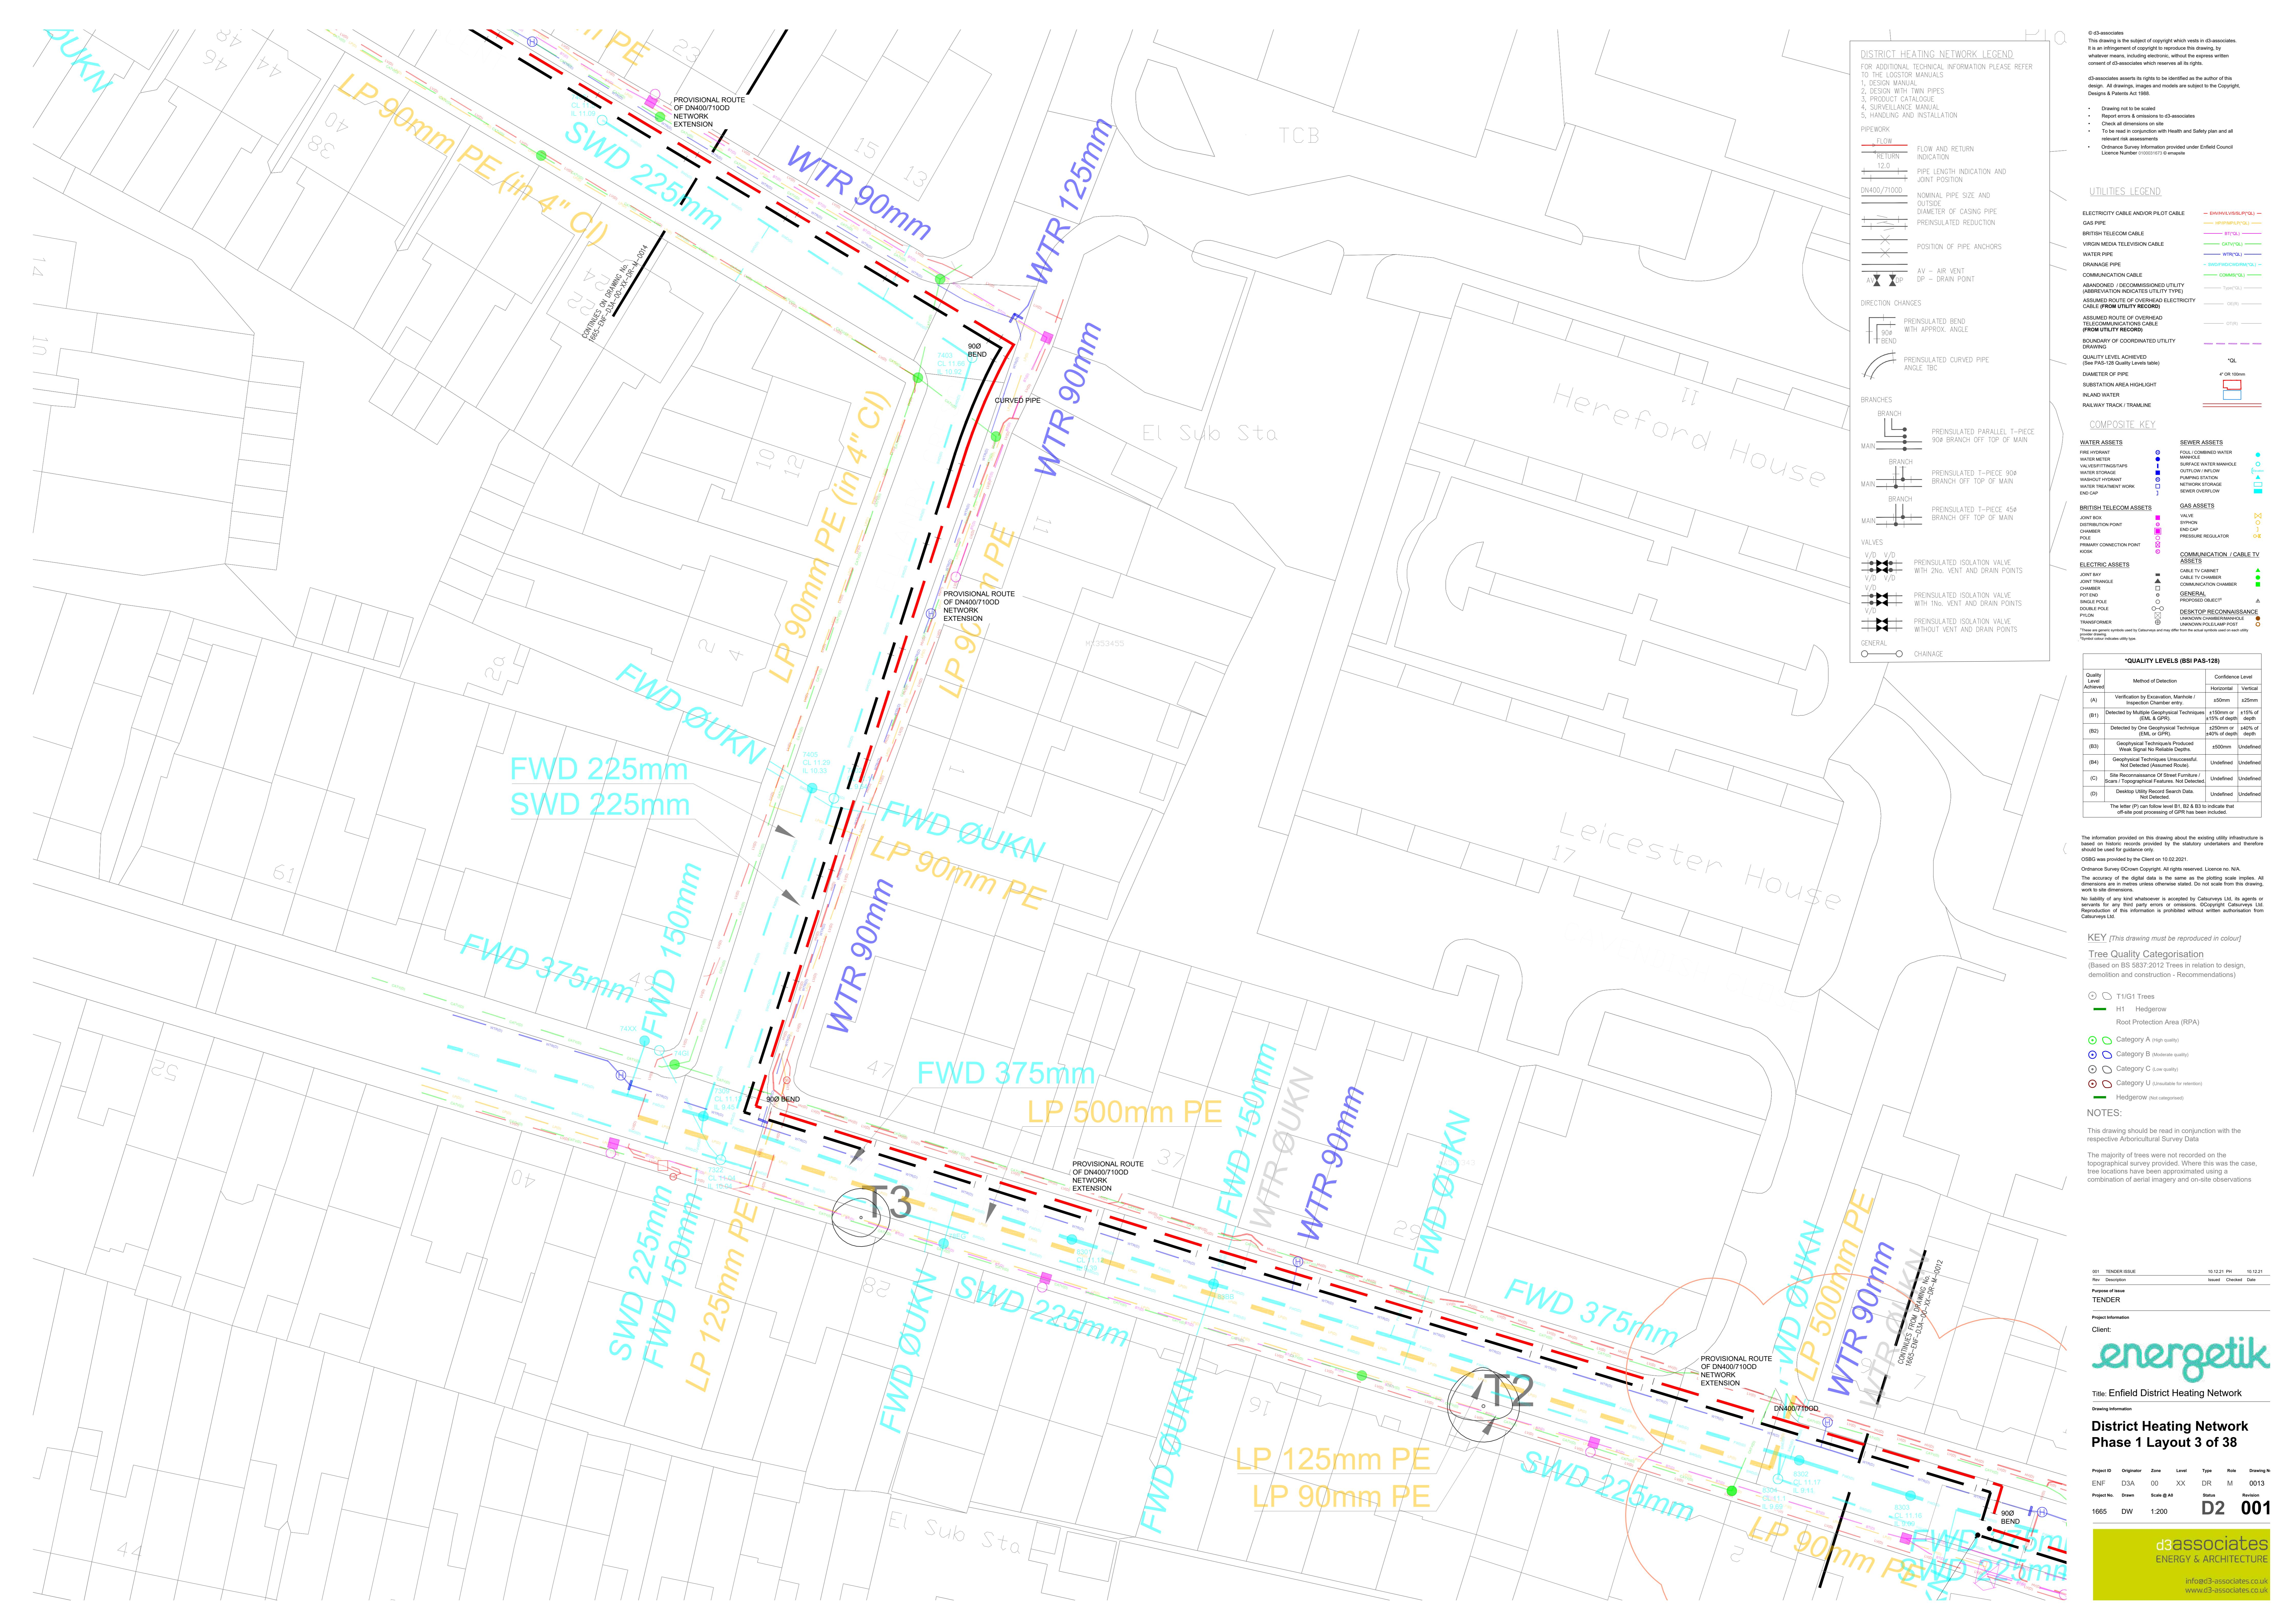PIPERWORK

FLOW
 RETURN
 12.0 J PIPE LENGTH INDICATION AND
JOINT POSITION
 DN400/7100D NOMINAL PIPE SIZE AND
OUTSIDE DIAMETER OF CASING PIPE
 PREINSULATED REDUCTION
 POSITION OF PIPE ANCHORS
 AV - AIR VENT DP - DRAIN POINT

DIRECTION CHANGES

PREINSULATED BEND
WITH APPROX. ANGLE
 PREINSULATED CURVED PIPE
ANGLE TBC

BRANCHES

MAIN
 BRANCH OFF TOP OF MAIN
 PREINSULATED PARALLEL T-PIECE 90°
BRANCH OFF TOP OF MAIN

MAIN
 BRANCH OFF TOP OF MAIN
 PREINSULATED T-PIECE 45°
BRANCH OFF TOP OF MAIN

VALVES

V/D - 1/2" PREINSULATED ISOLATION VALVE
WITH 2ND VENT AND DRAIN POINTS
 V/D - 1/2" PREINSULATED ISOLATION VALVE
WITH 1ST VENT AND DRAIN POINTS
 V/D PREINSULATED ISOLATION VALVE
WITHOUT VENT AND DRAIN POINTS

GENERAL

CHAINAGE

UTILITIES LEGEND

ELECTRICITY CABLE AND/OR PILOT CABLE
GAS PIPE
BRITISH TELECOM CABLE
VIRGIN MEDIA TELEVISION CABLE
WATER PIPE
DRAINAGE PIPE
COMMUNICATION CABLE
ABANDONED / DECOMMISSIONED UTILITY
(Symbol indicates utility type)
ASSUMED ROUTE OF OVERHEAD ELECTRICITY
CABLE (FROM UTILITY RECORD)
ASSUMED ROUTE OF OVERHEAD
TELEPHONE CABLE (FROM UTILITY RECORD)
(FROM UTILITY RECORD)
BOUNDARY OF COORDINATED UTILITY
DRAWINGS

QUALITY LEVEL ACHIEVED
(See PAS-128 Quality Levels table)

DIAETER OF PIPE

SUBSTATION AREA HIGHLIGHT

INLAND WATER

RAILWAY TRACK / TRAMLINE

COMPOSITE KEY

WATER ASSETS
FIRE HYDRANT
WATER METER
WATER METER TAPES
WATER STORAGE
WATER TOWER
WATER TREATMENT WORK
END CAP

SEWER ASSETS
FOUL / COMINDED WATER
MANHOLE
SURFACE WATER MANHOLE
OUTFLOW / INFLOW
POLLUTION CHAMBER
NETWORK STORAGE
SEWER OVERFLOW

GAS ASSETS

JOINT BOX
DISTRIBUTION POINT
GATE
POLE
PRIMARY CONNECTION POINT
PIPE

COMMUNICATION / CABLE TV
ASSETS

JOINT DAY
JOINT TRIANGLE
CHAMBER

CABLE TV CHAMBER

GENERAL

PROPOSED OBJECT

DESKTOP RECONNAISSANCE

UNASSIGNED

UNKNOWN POLE/AMP POST

Typical utility symbols used in this drawing
Symbol descriptions can be found in the Utilities section of the drawing

Quality levels table

"Quality Levels (BS PAS-128)"

Quality Level Achieved

Method of Detection

Horizontal Vertical

(A) Verification by Excavation, Machine / Inspection Chamber entry, +50mm

(B1) Detected by Multiples Geophysical Techniques +15% of depth

(B2) Detected by Single Geophysical Technique +15% of depth (EM, GPR)

(B3) Geophysical Techniques Produced +40% of depth

Geophysical Techniques Unsuccessful +40% of depth

(B4) Geophysical Techniques Unsuccessful, Not Detected (Assumed Route)

(C) Site Reconnaissance of Street Furniture / Scans (Geophysical Techniques), Not Detected

(D) Desktop Utility Record Search Data, Not Detected

The letter (P) can follow level B1, B2 & B3 to indicate that off-site post processing of GPR has been included.

The information provided on this drawing about the existing utility infrastructure is based on the best available data at the time of drawing. It is not necessarily up-to-date and therefore should be used for guidance only.

OSGB was used for coordinate reference system.

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KEY [This drawing must be reproduced in colour]

Tree Quality Categorisation

(Based on BS 5837:2012 Trees in relation to design, demolition and construction - Recommendations)

T1/H1 Trees

Hedgerow

Root Protection Area (RPA)

Category A (High quality)

Category B (Moderate quality)

Category C (Low quality)

Category U (Unusable for retention)

Hedgerow (not categorised)

NOTES:

This drawing should be read in conjunction with the respective Arboricultural Survey Data

The majority of trees were not recorded on the topographical survey provided. Where this was the case, tree locations have been approximated using a combination of aerial imagery and on-site observations

001 TENDER ISSUE 10.12.21 PH 10.12.21

Rev Description Issued Checked Date

Purpose of issue

Project Information

Client:

energetik

Title: Enfield District Heating Network

Drawing Information

District Heating Network

Phase 1 Layout 4 of 38

Project ID Originator Zone Level Type Role Drawing No.
ENF D3A 00 XX DR M 0014

Project No. Drawn Scale @ As Status Revision

1665 DW 1:200 D2 001

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• Report errors & omissions to d3-associates
• Check all dimensions on site
• To be read in conjunction with Health and Safety plan and all
relevant codes of practice
• Ordnance Survey Information provided under Ordnance Council Licence
Number 01000191710 envelope

DISTRICT HEATING NETWORK LEGEND

FOR ADDITIONAL TECHNICAL INFORMATION PLEASE REFER
TO THE FOLLOWING VOLUMES
1. DESIGN MANUALS
2. DESIGN WITH TWIN PIPES
3. PRODUCT CATALOGUE
4. SURVEILLANCE MANUAL
5. HANDLING AND INSTALLATION

PIPEWORK

| | | |
|--|--|---|
| | FLOW | FLOW AND RETURN INDICATION |
| | RETURN | 12.0 |
| | PIPE LENGTH INDICATION AND JOINT POSITION | |
| | DN400/7100D | NOMINAL PIPE SIZE AND OUTSIDE DIAMETER OF CASING PIPE |
| | PREINSULATED REDUCTION | |
| | POSITION OF PIPE ANCHORS | |
| | AV - AIR VENT | |
| | DP - DRAIN POINT | |

DIRECTION CHANGES

| | |
|--|---|
| | PREINSULATED BEND WITH APPROX. ANGLE |
| | PREINSULATED CURVED PIPE ANGLE 180° |

BRANCHES

| | |
|--|---|
| | PREINSULATED PARALLEL T-PIECE 90° BRANCH OFF TOP OF MAIN |
| | PREINSULATED T-PIECE 90° BRANCH OFF TOP OF MAIN |
| | PREINSULATED T-PIECE 45° BRANCH OFF TOP OF MAIN |

VALVES

| | |
|--|--|
| | PREINSULATED ISOLATION VALVE WITH 2ND VENT AND DRAIN POINTS |
| | PREINSULATED ISOLATION VALVE WITH 1ND VENT AND DRAIN POINTS |
| | PREINSULATED ISOLATION VALVE WITHOUT VENT AND DRAIN POINTS |

GENERAL

| | |
|--|----------|
| | CHAINAGE |
|--|----------|

UTILITIES LEGEND

| | |
|--|---|
| | ELECTRIC CABLE AND/OR PILOT CABLE |
| | GAS PIPE |
| | BRITISH TELECOM CABLE |
| | VIRGIN MEDIA TELEVISION CABLE |
| | WATER PIPE |
| | DRAINAGE PIPE |
| | COMMUNICATION PIPE |
| | ABANDONED / DECOMMISSIONED UTILITY (UNLESS OTHERWISE INDICATED UTILITY TYPE) |
| | ASSUMED ROUTE OF OVERHEAD ELECTRICITY CABLE (FROM UTILITY RECORD) |
| | ASSUMED ROUTE OF OVERHEAD TELECOMMUNICATIONS CABLE (FROM UTILITY RECORD) |
| | BOUNDARY OF COORDINATED UTILITY DRAWING |
| | QUALITY LEVEL INDICATION (See PAS-128 Quality Levels table) |
| | DIAETER OF PIPE |
| | SUBSTATION AREA HIGHLIGHT |
| | INLAND WATER |
| | RAILWAY TRACK / TRAMLINE |

COMPOSITE KEY

| | |
|--|------------------------------------|
| | WATER ASSETS |
| | FIRE HYDRANT |
| | WATER METER |
| | WATER STORAGE TANK |
| | WATER TREATMENT PLANT |
| | END CAP |
| | BRITISH TELECOM ASSETS |
| | JOINT BOX |
| | DISTRIBUTION POINT |
| | GPO |
| | POLE |
| | PRIMARY CONNECTION POINT |
| | PYLON |
| | ELECTRIC ASSETS |
| | JOINT DAY |
| | JOINT TRIANGLE CHAMBER |
| | CHAMBER |
| | POLE |
| | SINGLE POLE |
| | DOUBLE POLE |
| | PYLON |
| | TRANSFORMER |
| | COMMUNICATION / CABLE TV ASSETS |
| | CABLE TV CABINET |
| | CABLE TV CHAMBER |
| | COMMUNICATION CHAMBER |
| | GENERAL |
| | PROPOSED OBJECT |
| | UNKNOWN POLE/PALM POST |

| QUALITY LEVELS (BS PAS-128) | | |
|---|---------------------|---|
| Quality Level Achieved | Method of Detection | Confidence Level |
| (A) Verification by Excavation, Mobile / Inspection Chamber entry. | | Horizontal Vertical |
| (B1) Detected by Multiples Geophysical Techniques (EM, GPR). | | +50mm or +25mm |
| (B2) Detected by Geophysical Technique (EM, GPR). | | +15% of depth +15% of depth |
| (B3) Geophysical Techniques Produced Inconclusive Results. | | +40% of depth +40% of depth +50mm |
| (B4) Geophysical Techniques Unsuccessful. | | Undeclared Undeclared |
| (C) Site Reconnaissance Of Street Furniture / Scan / Droning / Other Method Not Detected. | | Undeclared Undeclared |
| (D) Desktop Utility Record Search Data. | | Undeclared Undeclared |

The letter (P) can follow level B1, B2 & B3 to indicate that off-site post processing of GPR has been included.

GD was issued by the date 10/12/21.

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Key [This drawing must be reproduced in colour]

Tree Quality Categorisation

(Based on BS 5837:2012 Trees in relation to design, demolition and construction - Recommendations)

| | |
|--|--|
| | T1/G1 TREES |
| | HEDGE ROW |
| | ROOT PROTECTION AREA (RPA) |
| | CATEGORY A (HIGH QUALITY) |
| | CATEGORY B (MODERATE QUALITY) |
| | CATEGORY C (LOW QUALITY) |
| | CATEGORY U (UNSUITEABLE FOR RETENTION) |
| | HEDGEROW (NOT CATEGORISED) |

NOTES:

This drawing should be read in conjunction with the respective Arboricultural Survey Data

The majority of trees were not recorded on the topographical survey provided. Where this was the case, tree locations have been approximated using a combination of aerial imagery and on-site observations

001 TENDER ISSUE 10/12/21 PH 10/12/21

Rev Description Issued Checked Date

Purpose of issue

TENDER

Project Information

Client:

energetik

Title: Enfield District Heating Network

Drawing Information

District Heating Network

Phase 1 Layout 5 of 38

Project ID Originator Zone Level Type Role Drawing No.

ENF D3A 00 XX DR M 0015


Project No. Draw Status Revision

1665 DW 1:200 D2 001

d3associates ENERGY & ARCHITECTURE

info@d3-associates.co.uk

www.d3-associates.co.uk

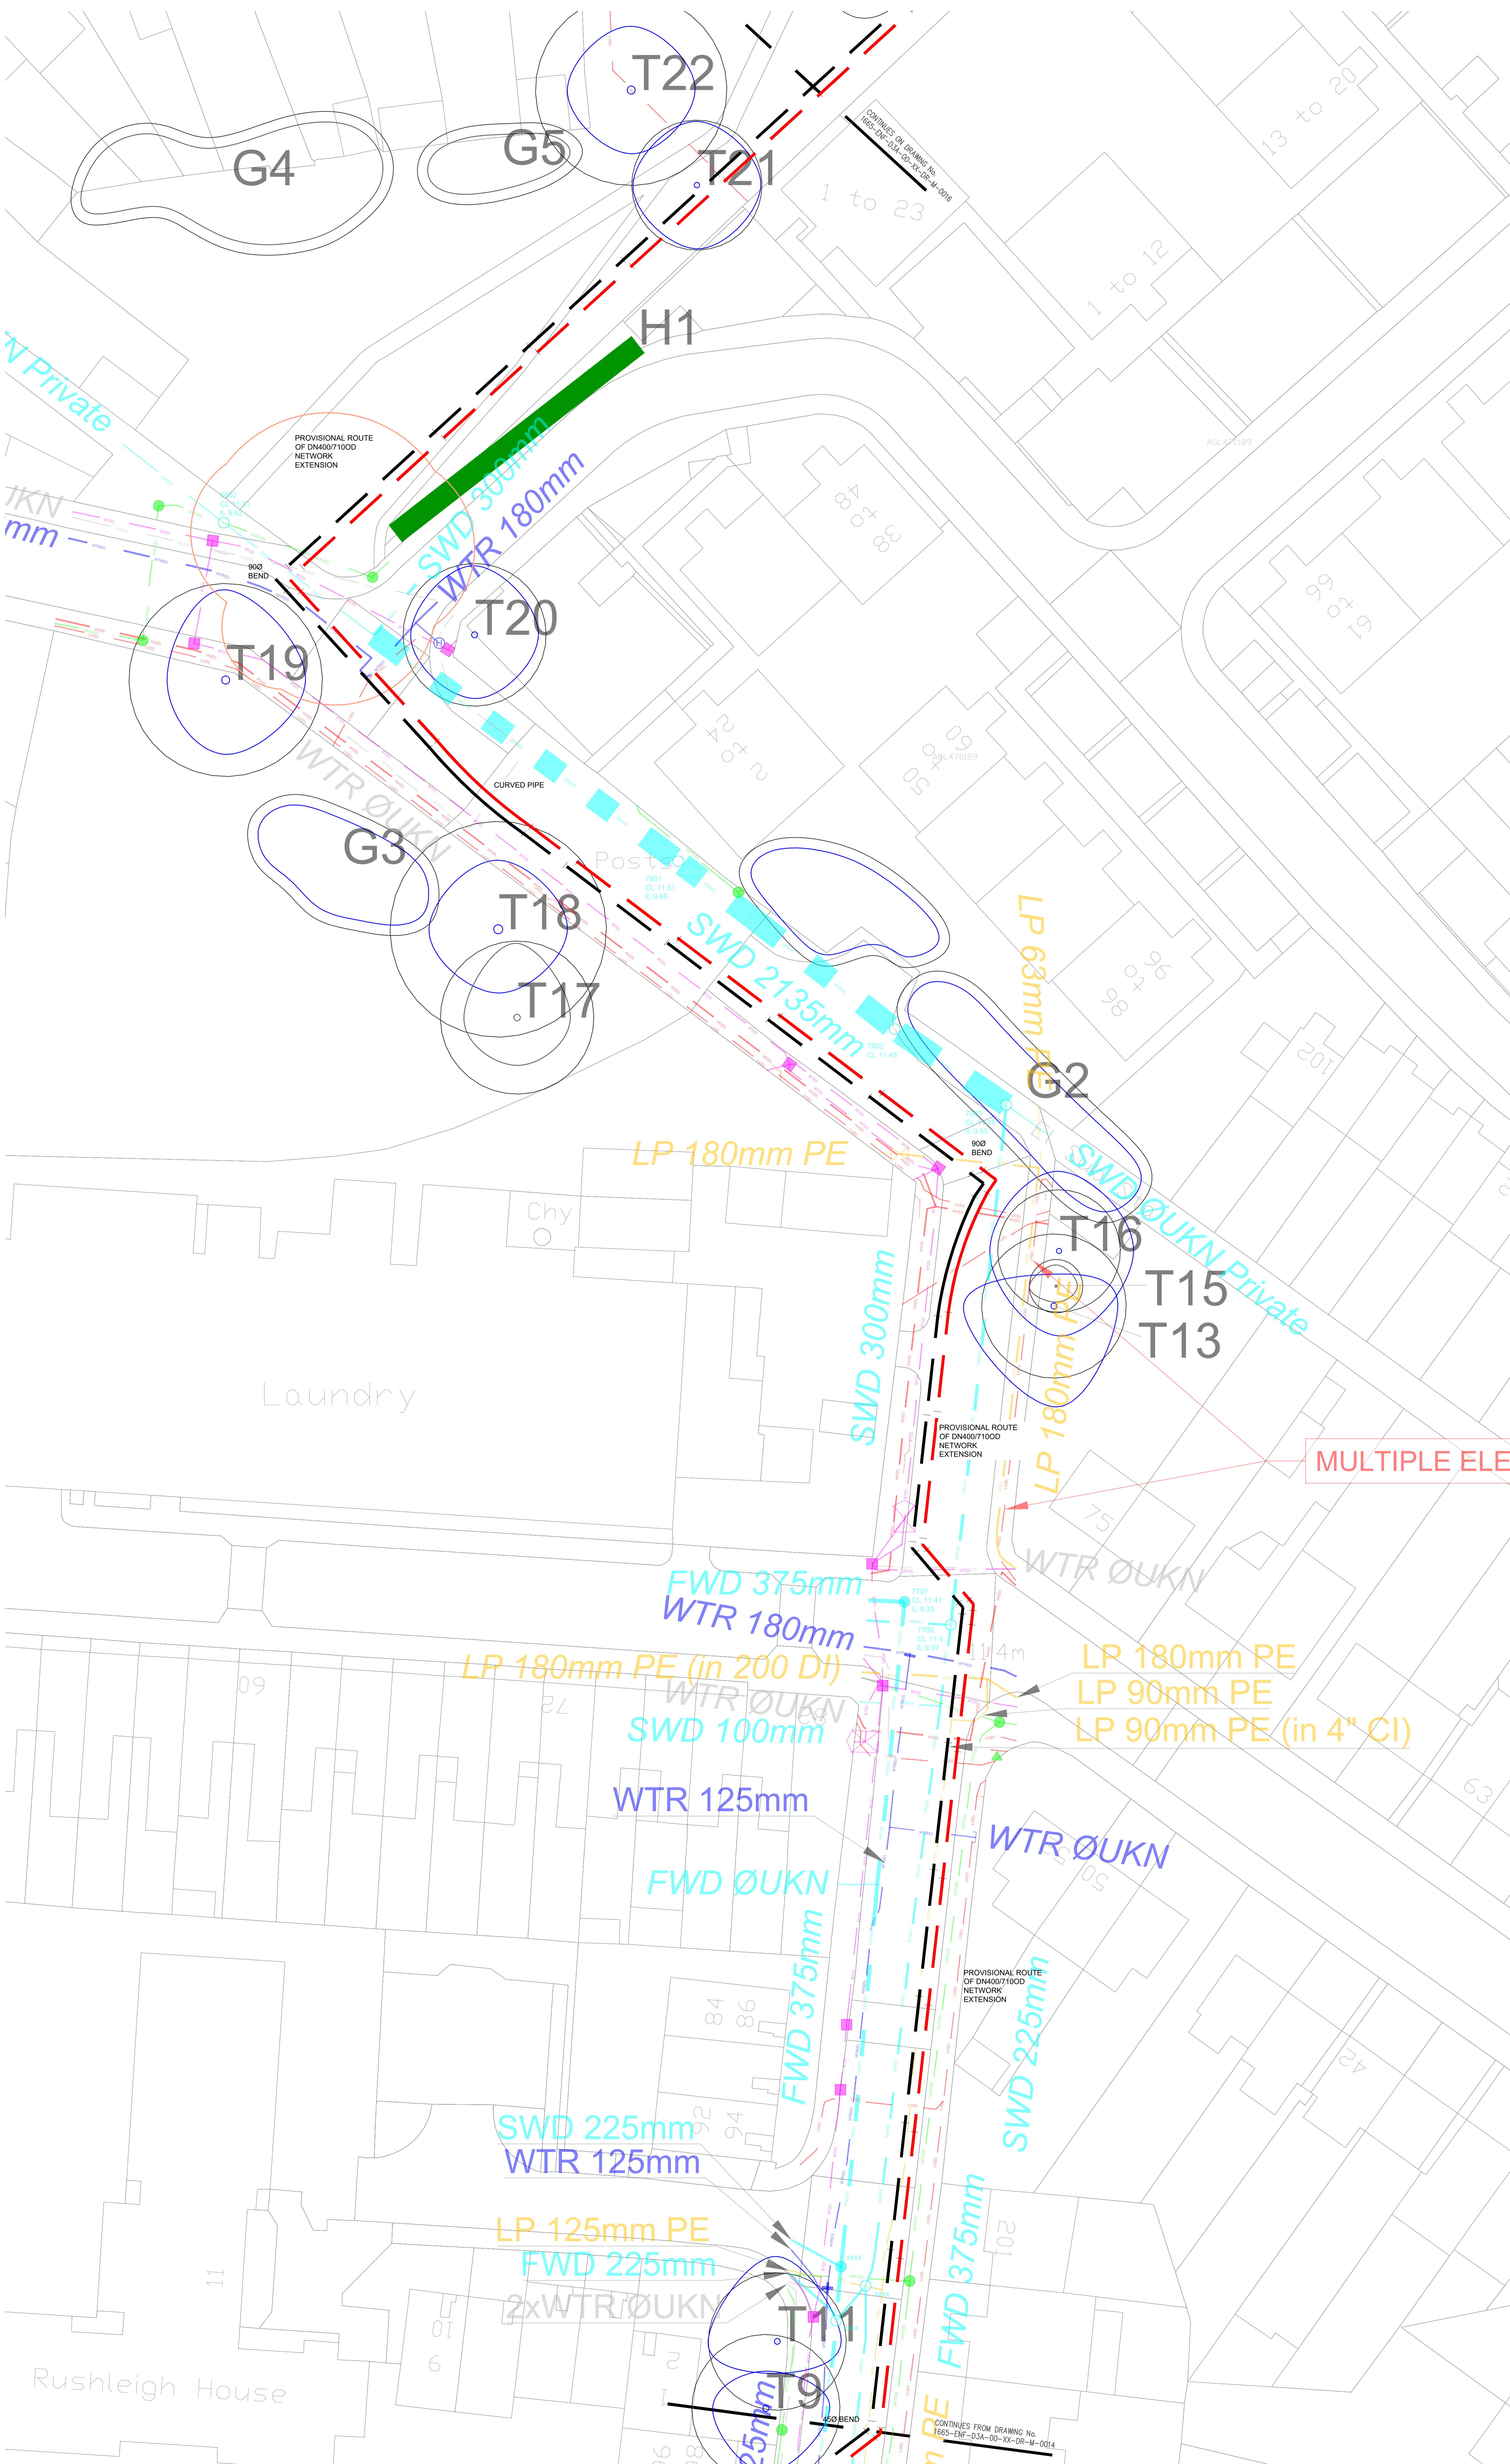

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DISTRICT HEATING NETWORK LEGEND

FOR ADDITIONAL TECHNICAL INFORMATION PLEASE REFER
TO THE FOLLOWING MANUALS

1. DESIGN MANUAL
2. DESIGN WITH TWIN PIPES
3. PRODUCT CATALOGUE
4. SIZING AND DESIGN MANUAL
5. HANDLING AND INSTALLATION

PIPEWORK

| | | |
|--|-------------|---|
| | FLOW | FLOW AND RETURN INDICATION |
| | RETURN | |
| | 12.0 | PIPE LENGTH INDICATION AND JOINT POSITION |
| | DN400/7100D | NOMINAL PIPE SIZE AND OUTSIDE DIAMETER OF CASING PIPE |
| | | PREINSULATED REDUCTION |
| | | POSITION OF PIPE ANCHORS |
| | AV DOP | AV - AIR VENT DOP - DRAIN POINT |

DIRECTION CHANGES

| | |
|--|---|
| | PREINSULATED BEND WITH APPROX. ANGLE |
| | PREINSULATED CURVED PIPE ANGLE IBC |

| | | |
|--|--------|---|
| | BRANCH | PREINSULATED PARALLEL T-PIECE 90° BRANCH OFF TOP OF MAIN |
| | BRANCH | PREINSULATED T-PIECE 90° BRANCH OFF TOP OF MAIN |
| | BRANCH | PREINSULATED T-PIECE 45° BRANCH OFF TOP OF MAIN |

| | | |
|--|--------|---|
| | VALVES | PREINSULATED ISOLATION VALVE WITH 2NC. VENT AND DRAIN POINTS |
| | | PREINSULATED ISOLATION VALVE WITH 1NC. VENT AND DRAIN POINTS |
| | | PREINSULATED ISOLATION VALVE WITHOUT VENT AND DRAIN POINTS |

GENERAL

| | | |
|--|---------|----------|
| | GENERAL | CHAINAGE |
|--|---------|----------|

UTILITIES LEGEND

| | | |
|--|--|------------------------|
| | ELECTRICITY CABLE AND/OR PILOT CABLE | - ENVIROVILS/BSY/OLY - |
| | GAS PIPE | - HP/HPM/OLY - |
| | BRITISH TELECOM CABLE | - BT/BSL - |
| | VIRGIN MEDIA TELEVISION CABLE | - CATV/CATV - |
| | WATER PIPE | - WTP/WTP/OLY - |
| | DRAINAGE PIPE | - DW/DW/OLY - |
| | COMMUNICATION CABLE | - COMM/COMM - |
| | ABANDONED / DECOMMISSIONED UTILITY (ABOVE LINE INDICATES ASSUMED TYPE) | - TYPE/TYPE - |
| | ASSUMED ROUTE OF OVERHEAD ELECTRICITY CABLE (FROM UTILITY RECORD) | - GPR/GPR - |
| | ASSUMED ROUTE OF OVERHEAD TELECOMMUNICATION CABLE (FROM UTILITY RECORD) | - OTR/OTR - |
| | BOUNDARY OF COORDINATED UTILITY DRAWING | - |
| | QUALITY LEVEL ACHIEVED (See PAS-128 Quality Levels table) | - |
| | DIA/TERMINAL DIAMETER OF PIPE | - |
| | SUBSTATION AREA HIGHLIGHT | - |
| | INLAND WATER | - |
| | RAILWAY TRACK / TRAMLINE | - |

COMPOSITE KEY

| | | |
|--|--------------------------|------------------------------------|
| | WATER ASSETS | SEWER ASSETS |
| | HYDRANT | SEWER |
| | WATER METER | MANHOLE |
| | WATER STORAGE | OUTFLOW / INFLOW |
| | MANUFACTURE | PUMP STATION |
| | WATER TREATMENT WORK | NETWORK STORAGE |
| | END CAP | SEWER OVERFLOW |
| | BRITISH TELECOM ASSETS | GAS ASSETS |
| | JOINT BOX | VALVE |
| | DISTRIBUTION POINT | END CAP |
| | CHAMBER | PRESSURE REGULATOR |
| | POLE | |
| | PRIMARY CONNECTION POINT | |
| | ELECTRIC ASSETS | COMMUNICATION / CABLE TV ASSETS |
| | JOINT BAY | CABLE TV CABINET |
| | JOINT TRIANGLE | CABLE TV CHAMBER |
| | CHAMBER | GENERAL |
| | POLE | PROPOSED OBJECT |
| | SINGLE POLE | DESKTOP RECONNAISSANCE |
| | DOUBLE POLE | UNKNOWN POLE/AMP |
| | PYLON | UNKNOWN POLE/AMP POST |

| *QUALITY LEVELS (BS PAS-128) | | |
|--|---------------------|----------------------|
| Quality Level Achieved | Method of Detection | Confidence Level |
| (A) Verified by Excavation, Manhole / Inspection Chamber entry | | Horizontal Vertical |
| (B1) Detected by Multiples Geophysical Techniques (EM, GPR, GPS) | | <25mm <25mm |
| (B2) Detected by Geophysical Technique (EM, GPR) | | 1150mm >15% of depth |
| (B3) Geophysical Techniques Produce Ambiguous Results (EM or GPR) | | 400mm >40% of depth |
| (B4) Geophysical Techniques Unsuccessful, Not Detected (Assumed Route) | | <500mm Undefined |
| (C) Site Reconnaissance Of Street Furniture / Manholes Not Detected | | Undefined Undefined |
| (D) Desktop Using Record Search Data, Not Detected | | Undefined Undefined |

The letter (P) can follow levels B, B2 & B3 to indicate that off-site post processing of GPR has been included.

The information provided on this drawing is about the existing utility infrastructure is intended for use by the client and its contractors. It is not to be used for statutory undertakers and therefore should be used for guidance only.

OSGB coordinate system is used. Grid reference: TQ 102 211.

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KEY [This drawing must be reproduced in colour]

Tree Quality Categorisation
(Based on BS 5837:2012 Trees in relation to design, demolition and construction - Recommendations)

| | |
|--|-------------------------------------|
| | T1/G1 TREES |
| | HEDGE ROW |
| | ROOT PROTECTION AREA (RPA) |
| | CATEGORY A (HIGH QUALITY) |
| | CATEGORY B (MODERATE QUALITY) |
| | CATEGORY Q (LOW QUALITY) |
| | CATEGORY U (UNUSABLE FOR RETENTION) |
| | HEDGE ROW (NOT CATEGORISED) |

NOTES:

This drawing should be read in conjunction with the respective Arboricultural Survey Data.

The majority of trees were not recorded on the topographical survey provided. Where this was the case, tree locations have been approximated using a combination of aerial imagery and on-site observations.

| 001 TENDER ISSUE | 10.12.21 PH | 10.12.21 |
|---------------------|-------------|----------|
| Rev Description | | |
| Purpose of issue | | |
| TENDER | | |
| Project Information | | |
| Client: | | |

energetik

Title: Enfield District Heating Network


District Heating Network


Phase 1 Layout 6 of 38


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| Project No. | Drawn | Scale @ As | | Status | | Revision |


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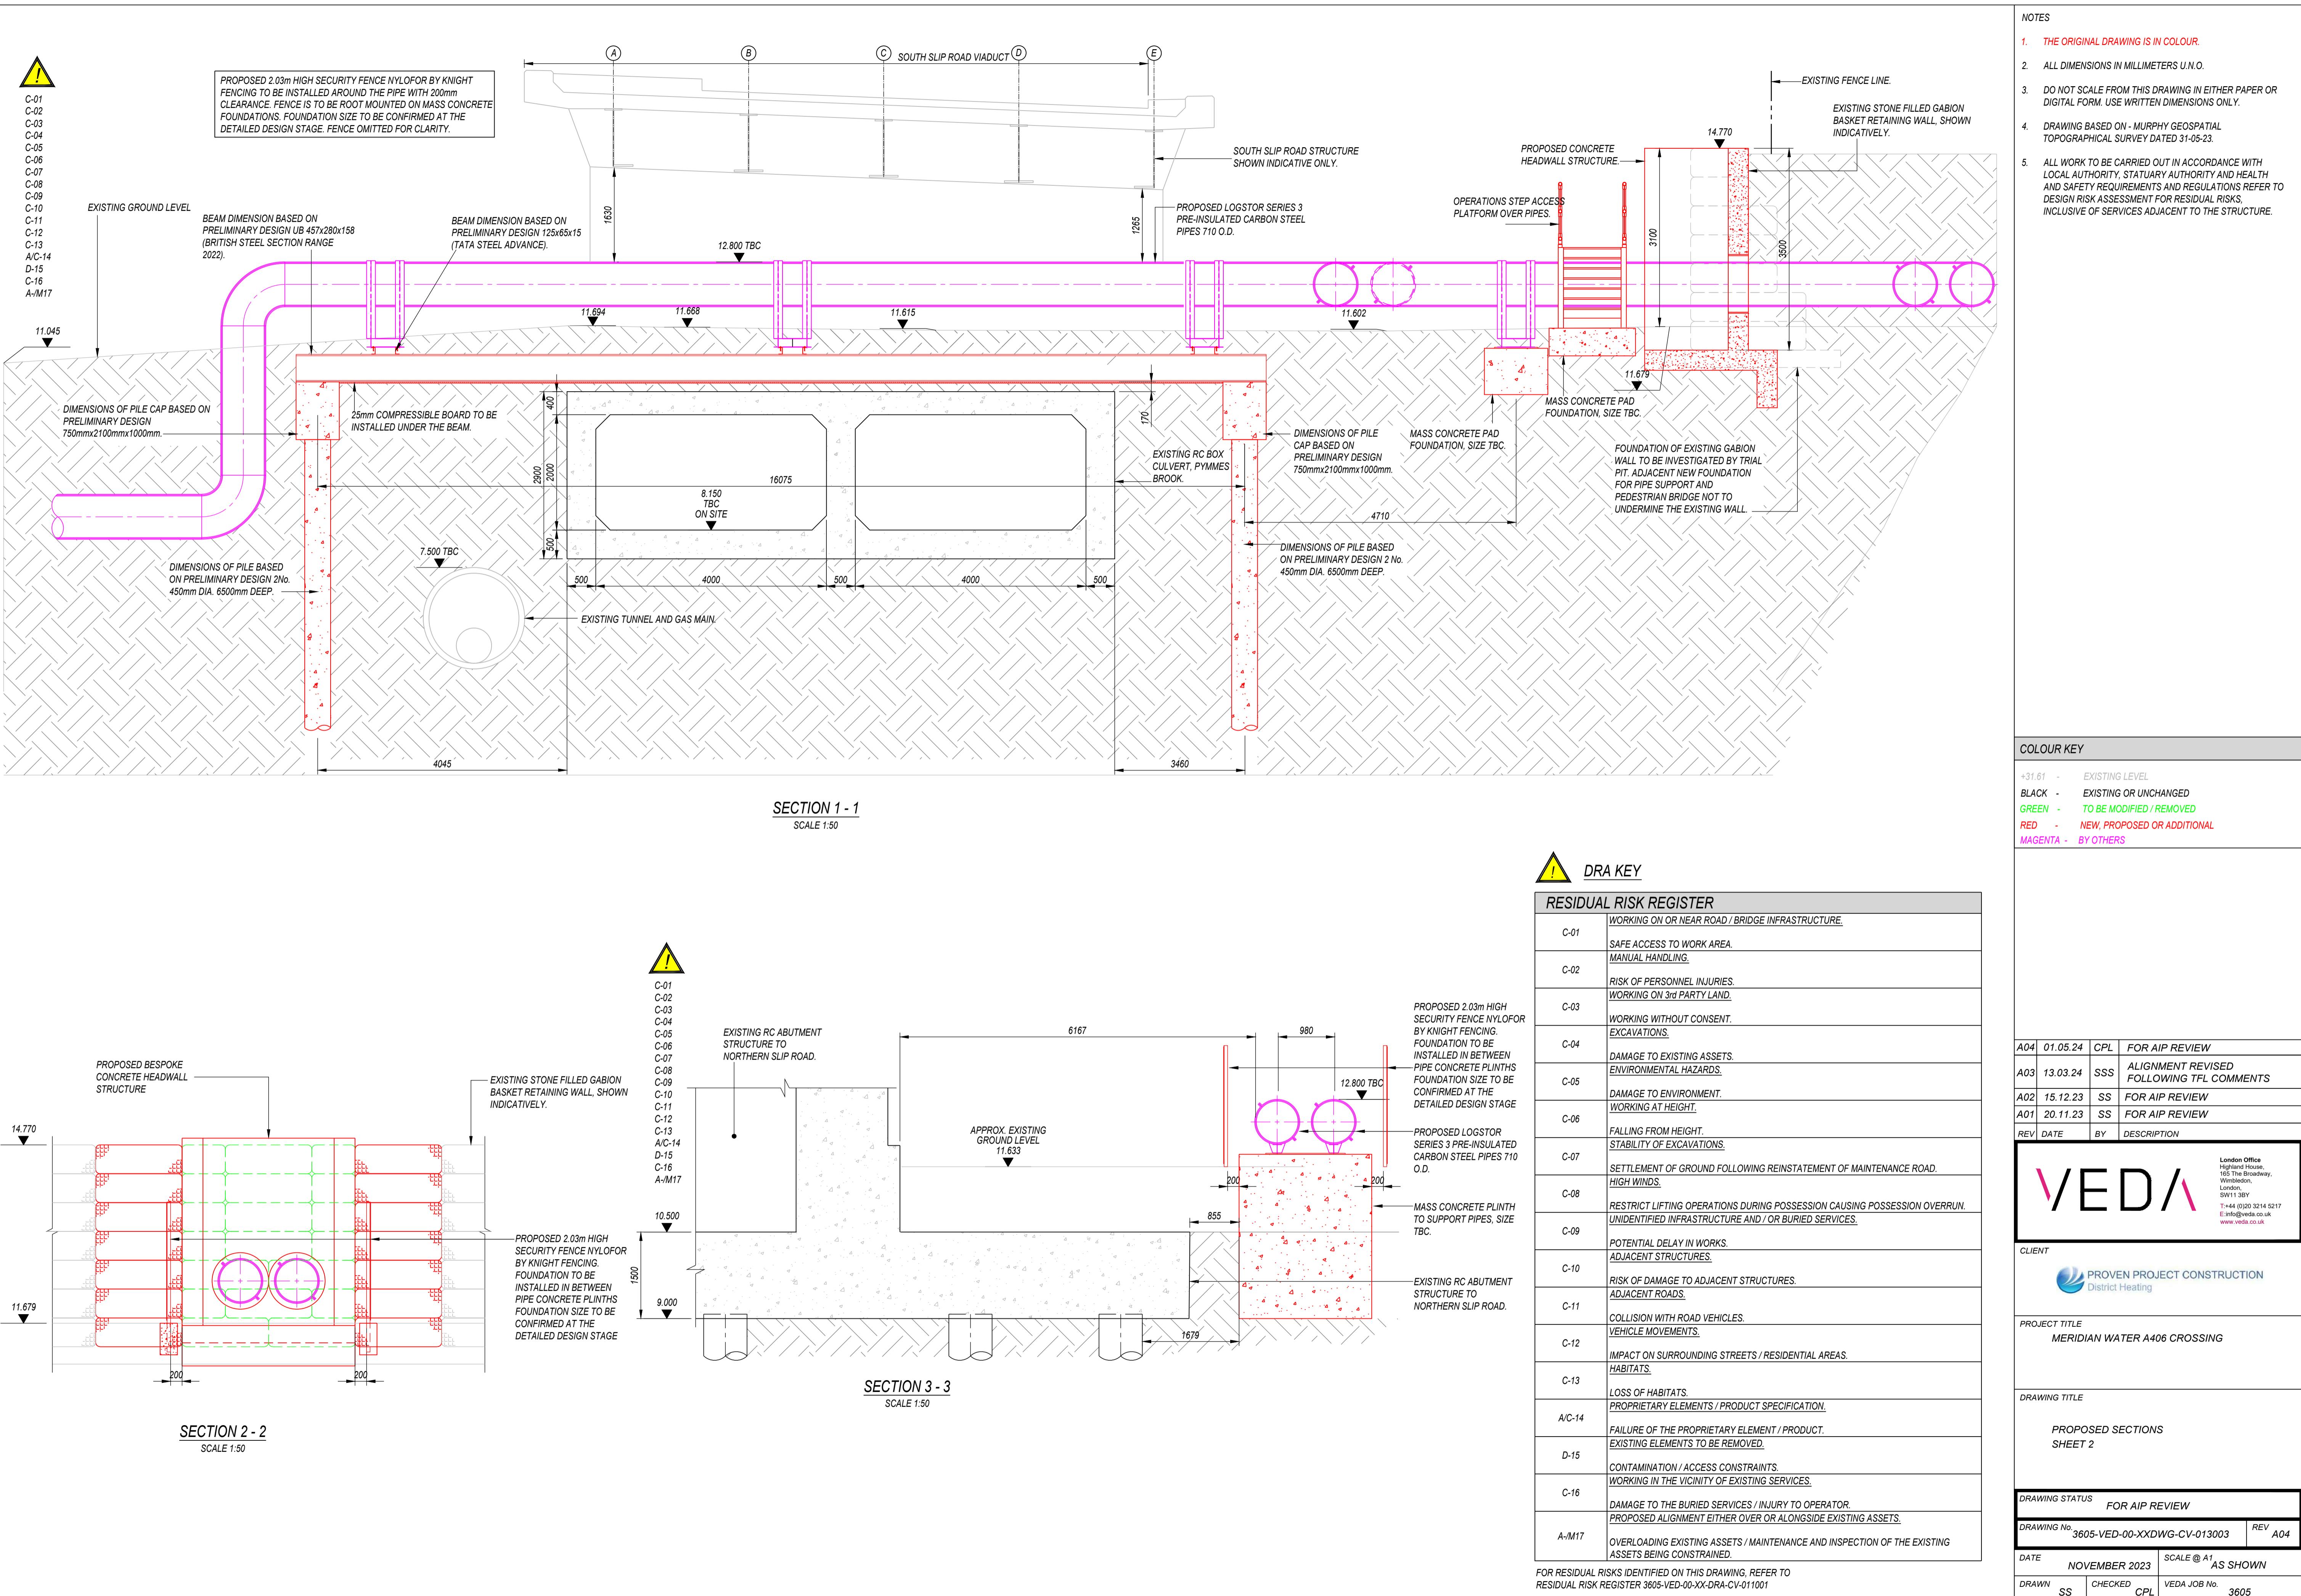
d3associates
ENERGY & ARCHITECTURE
info@d3-associates.co.uk
www.d3-associates.co.uk




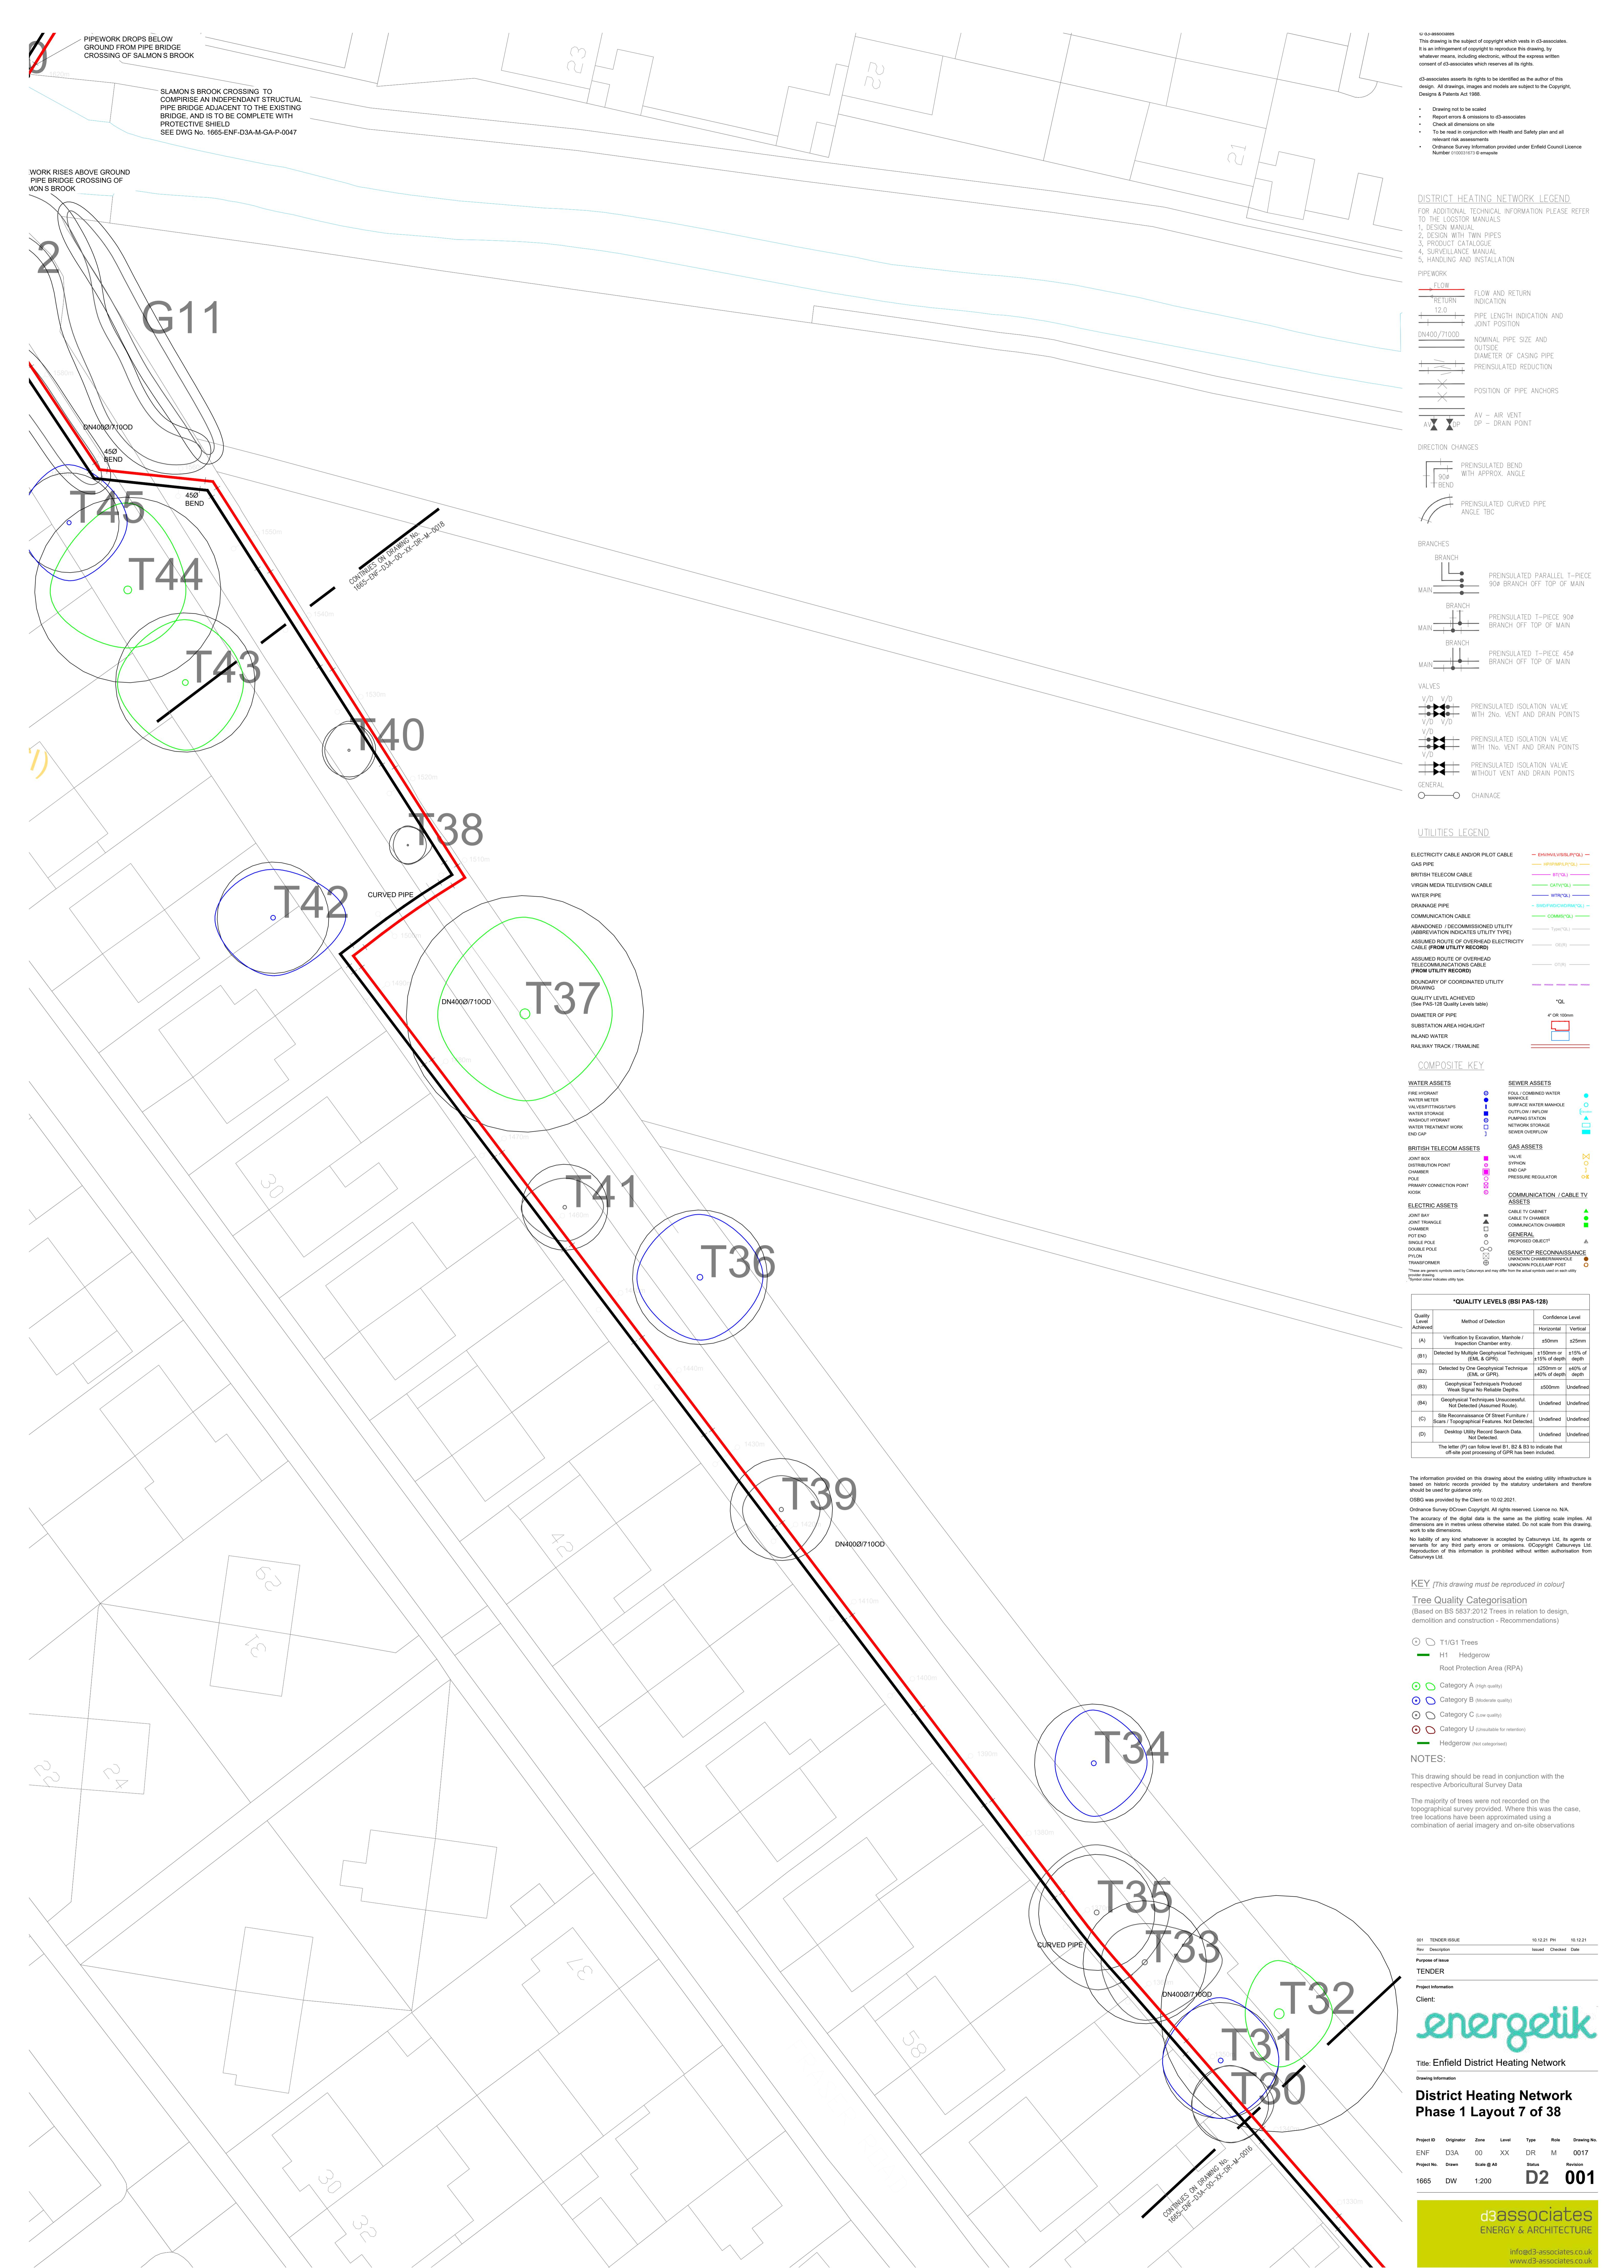

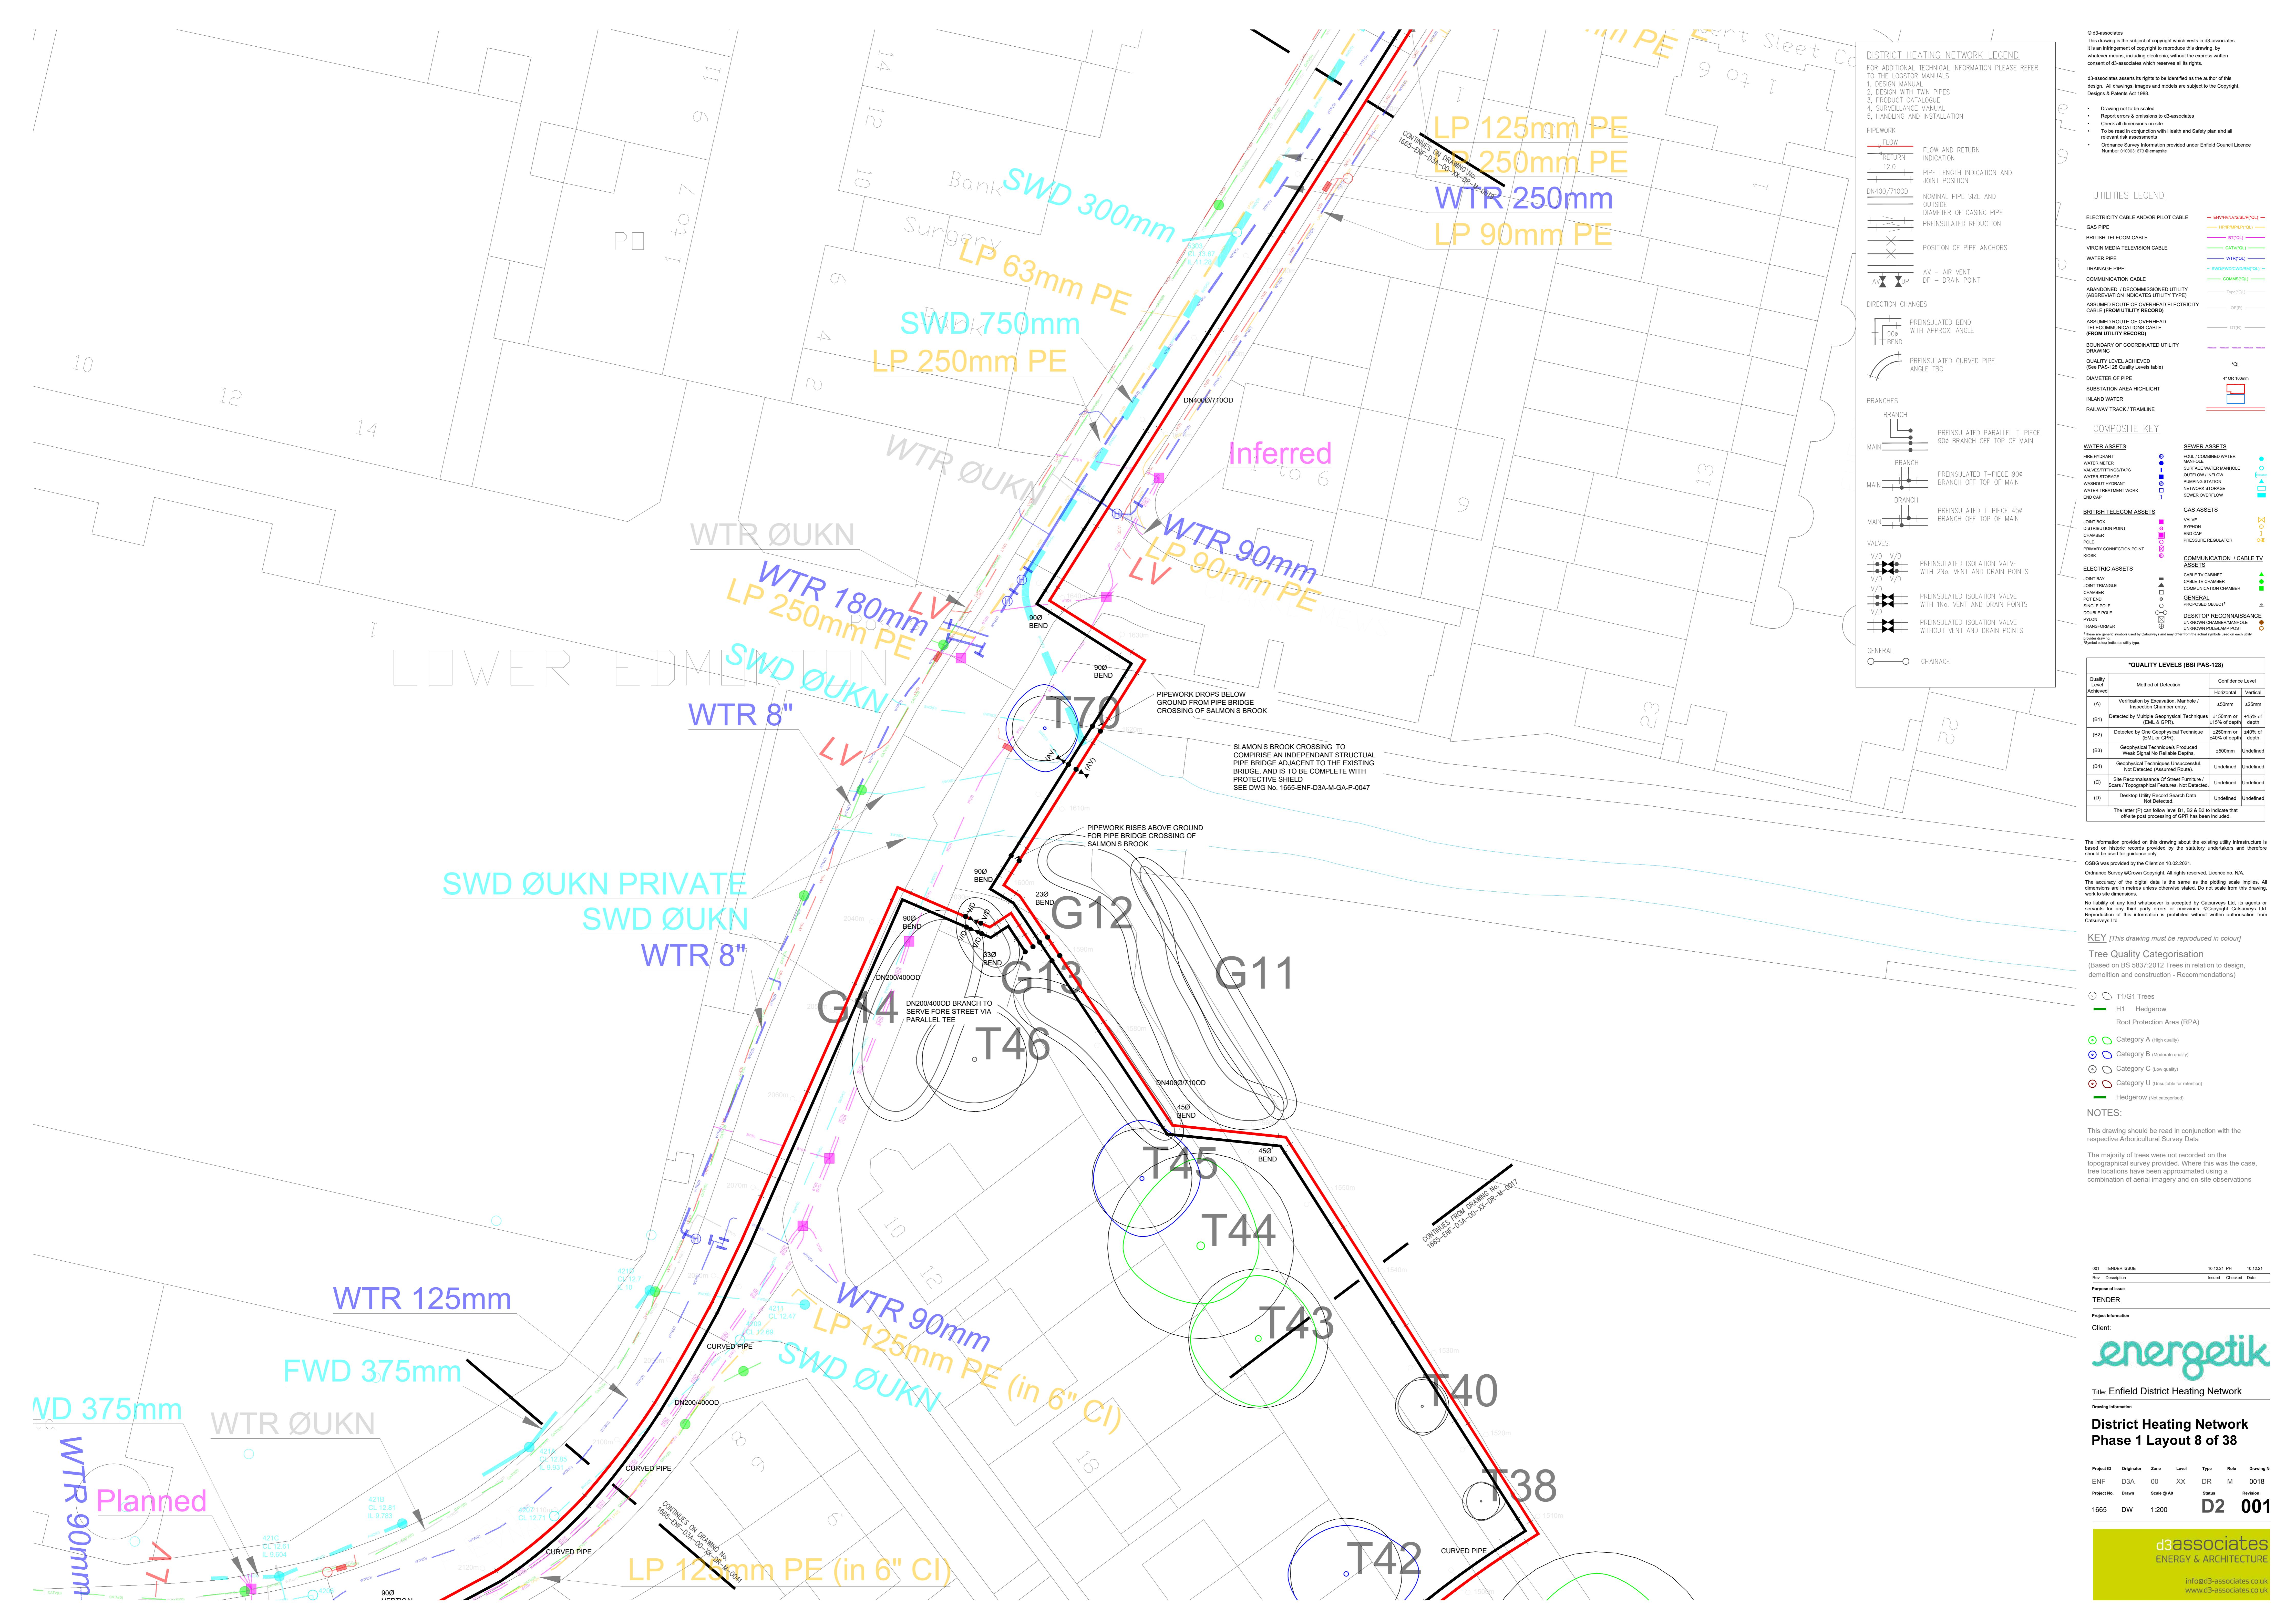

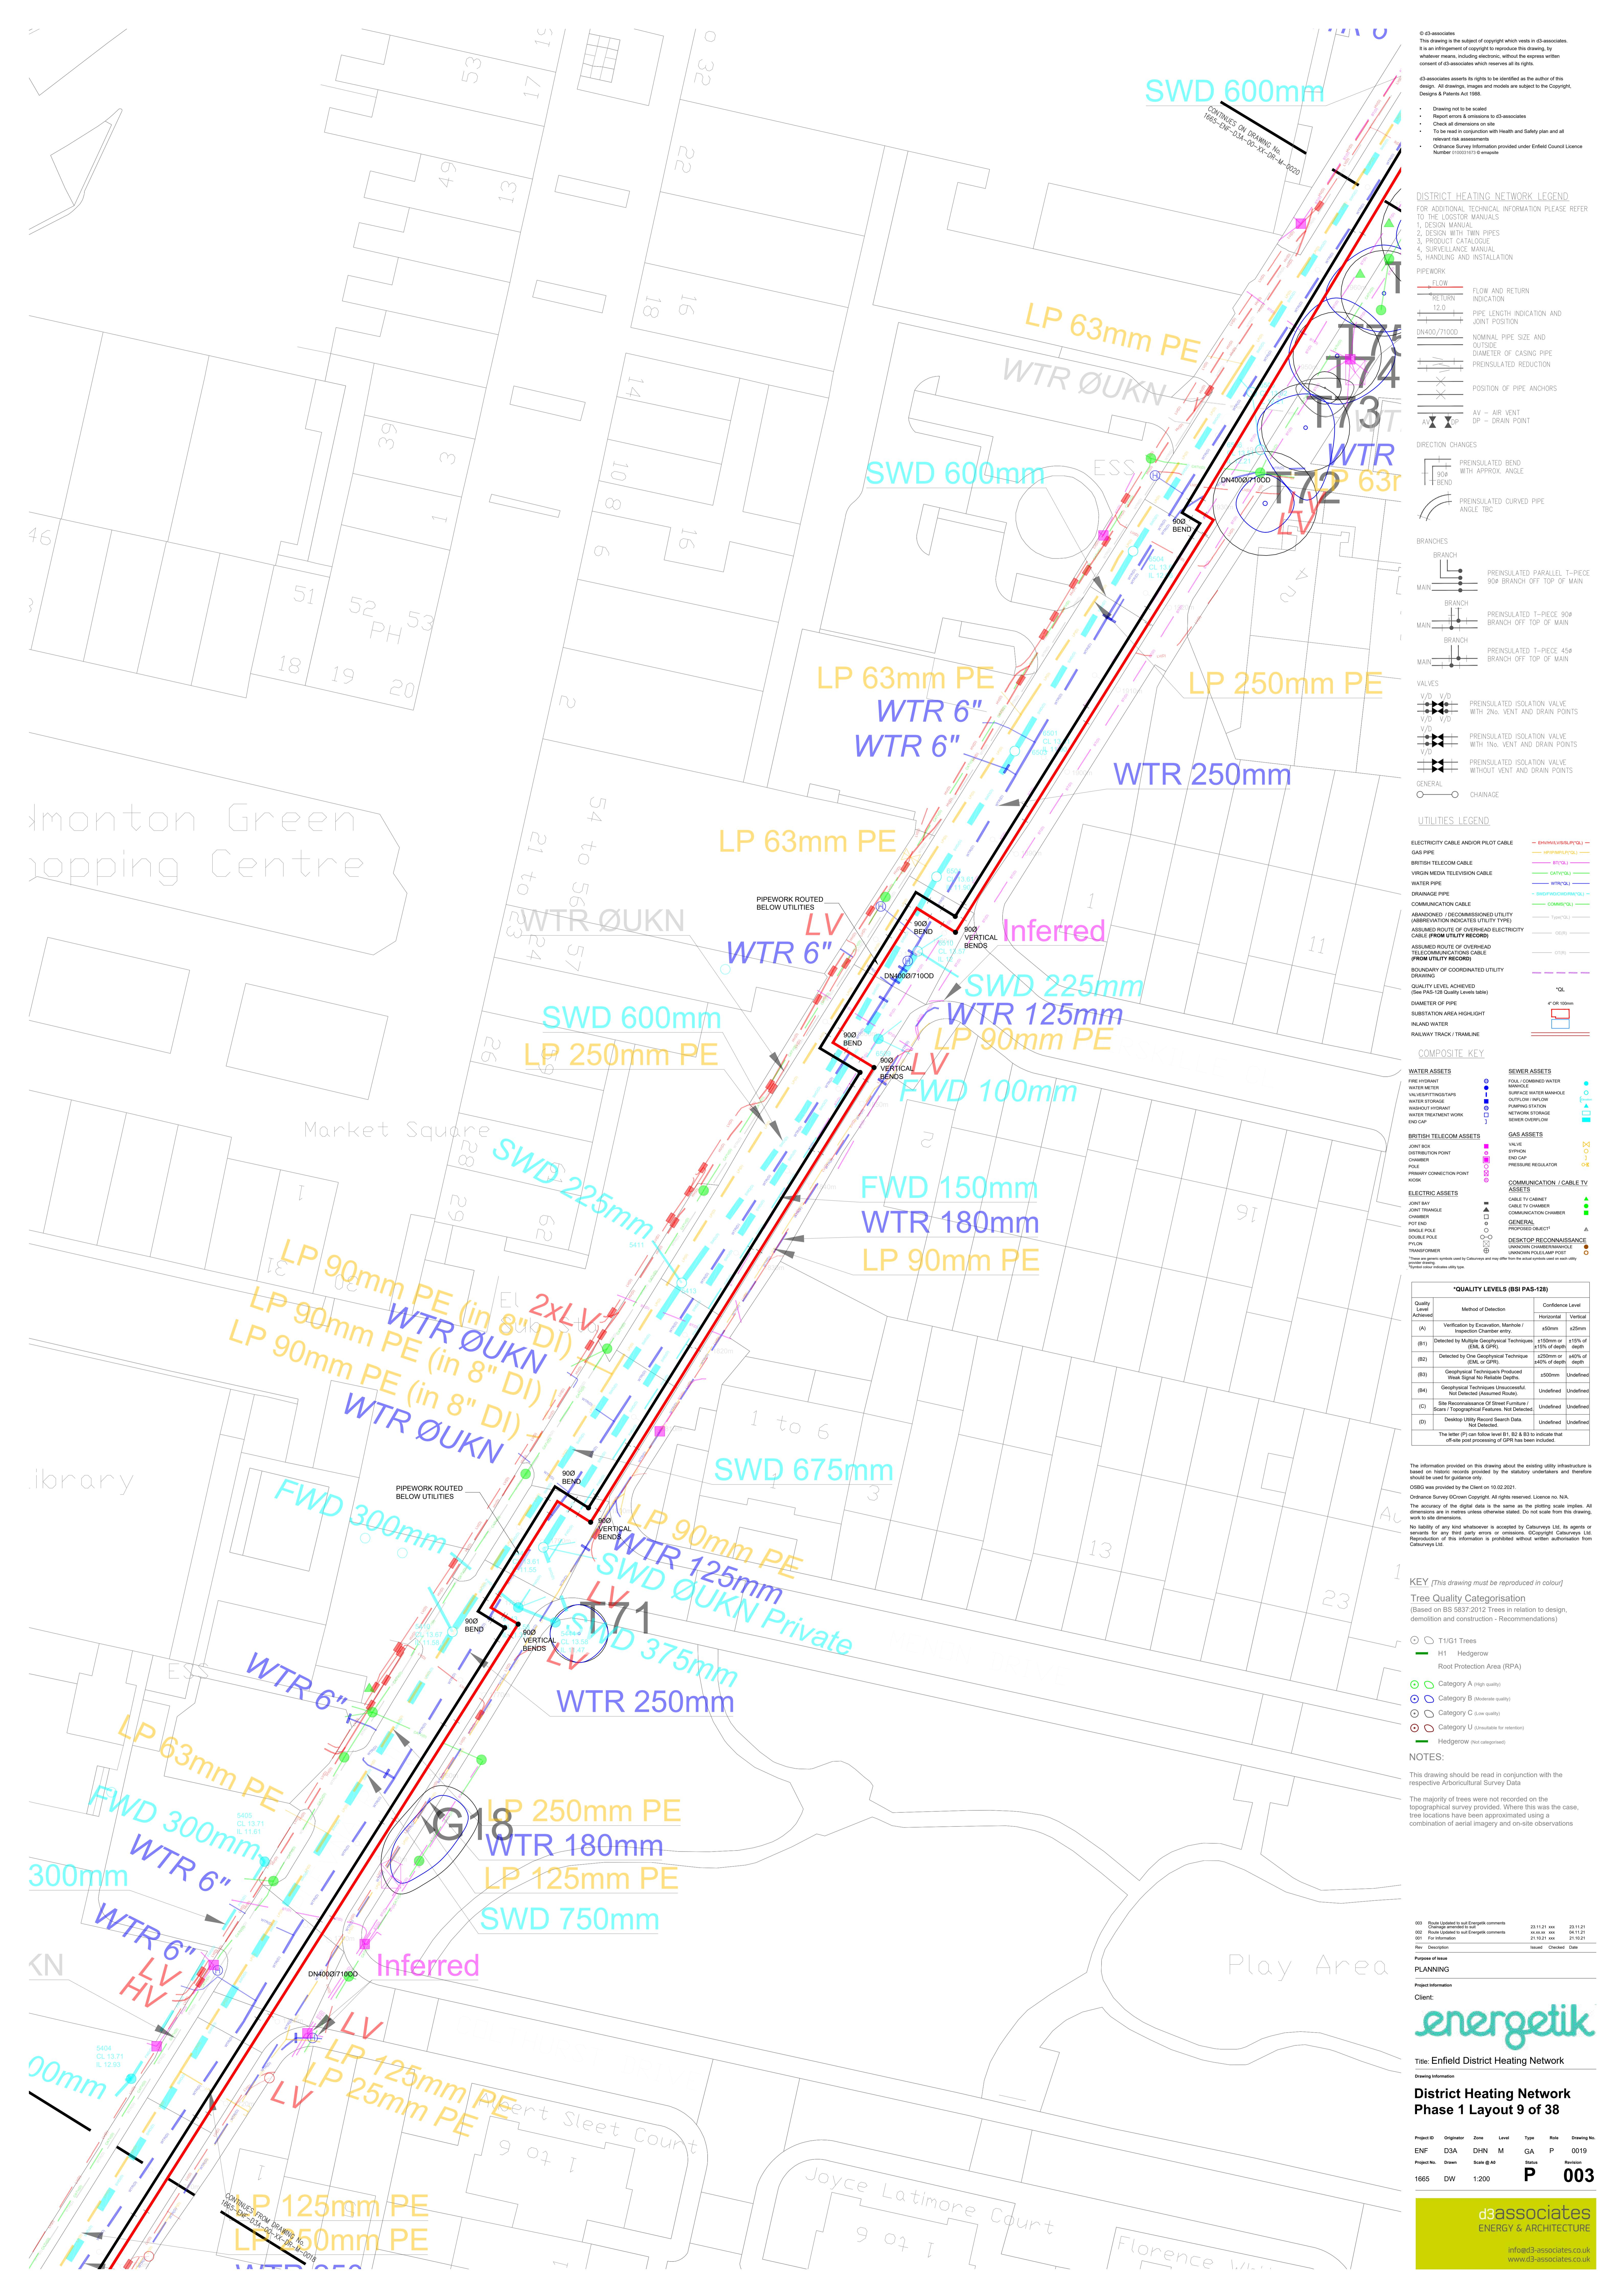


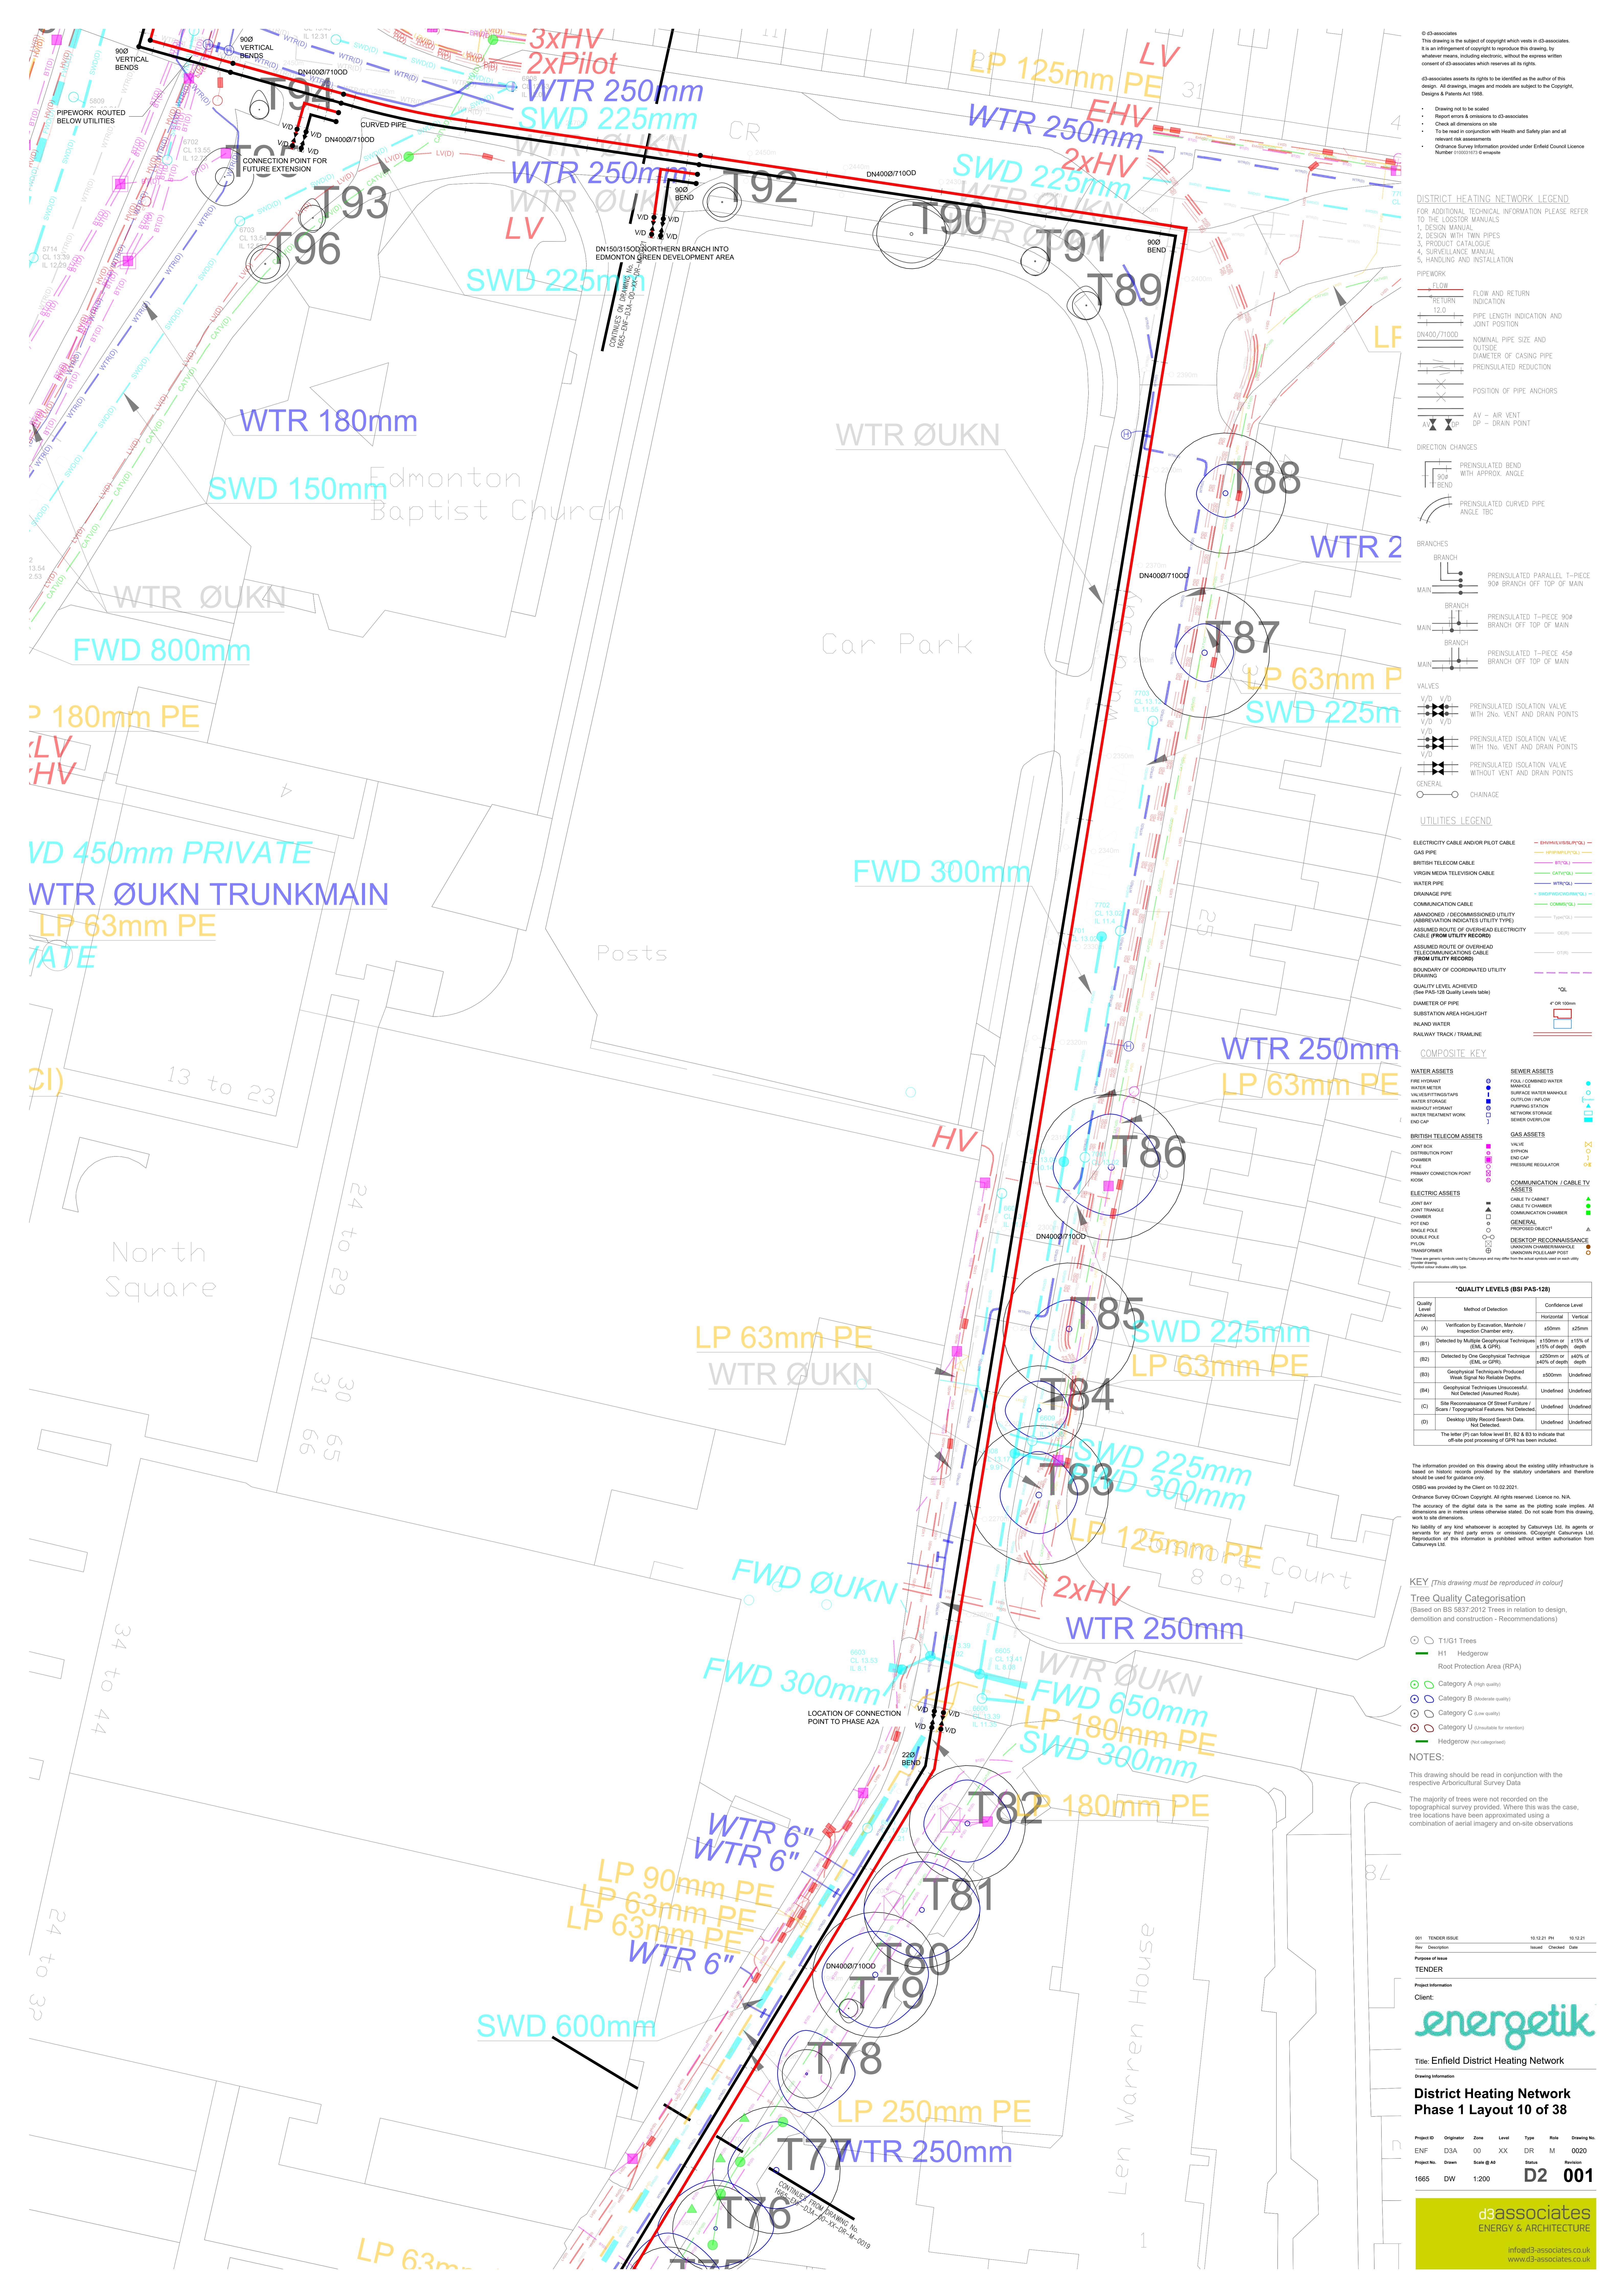

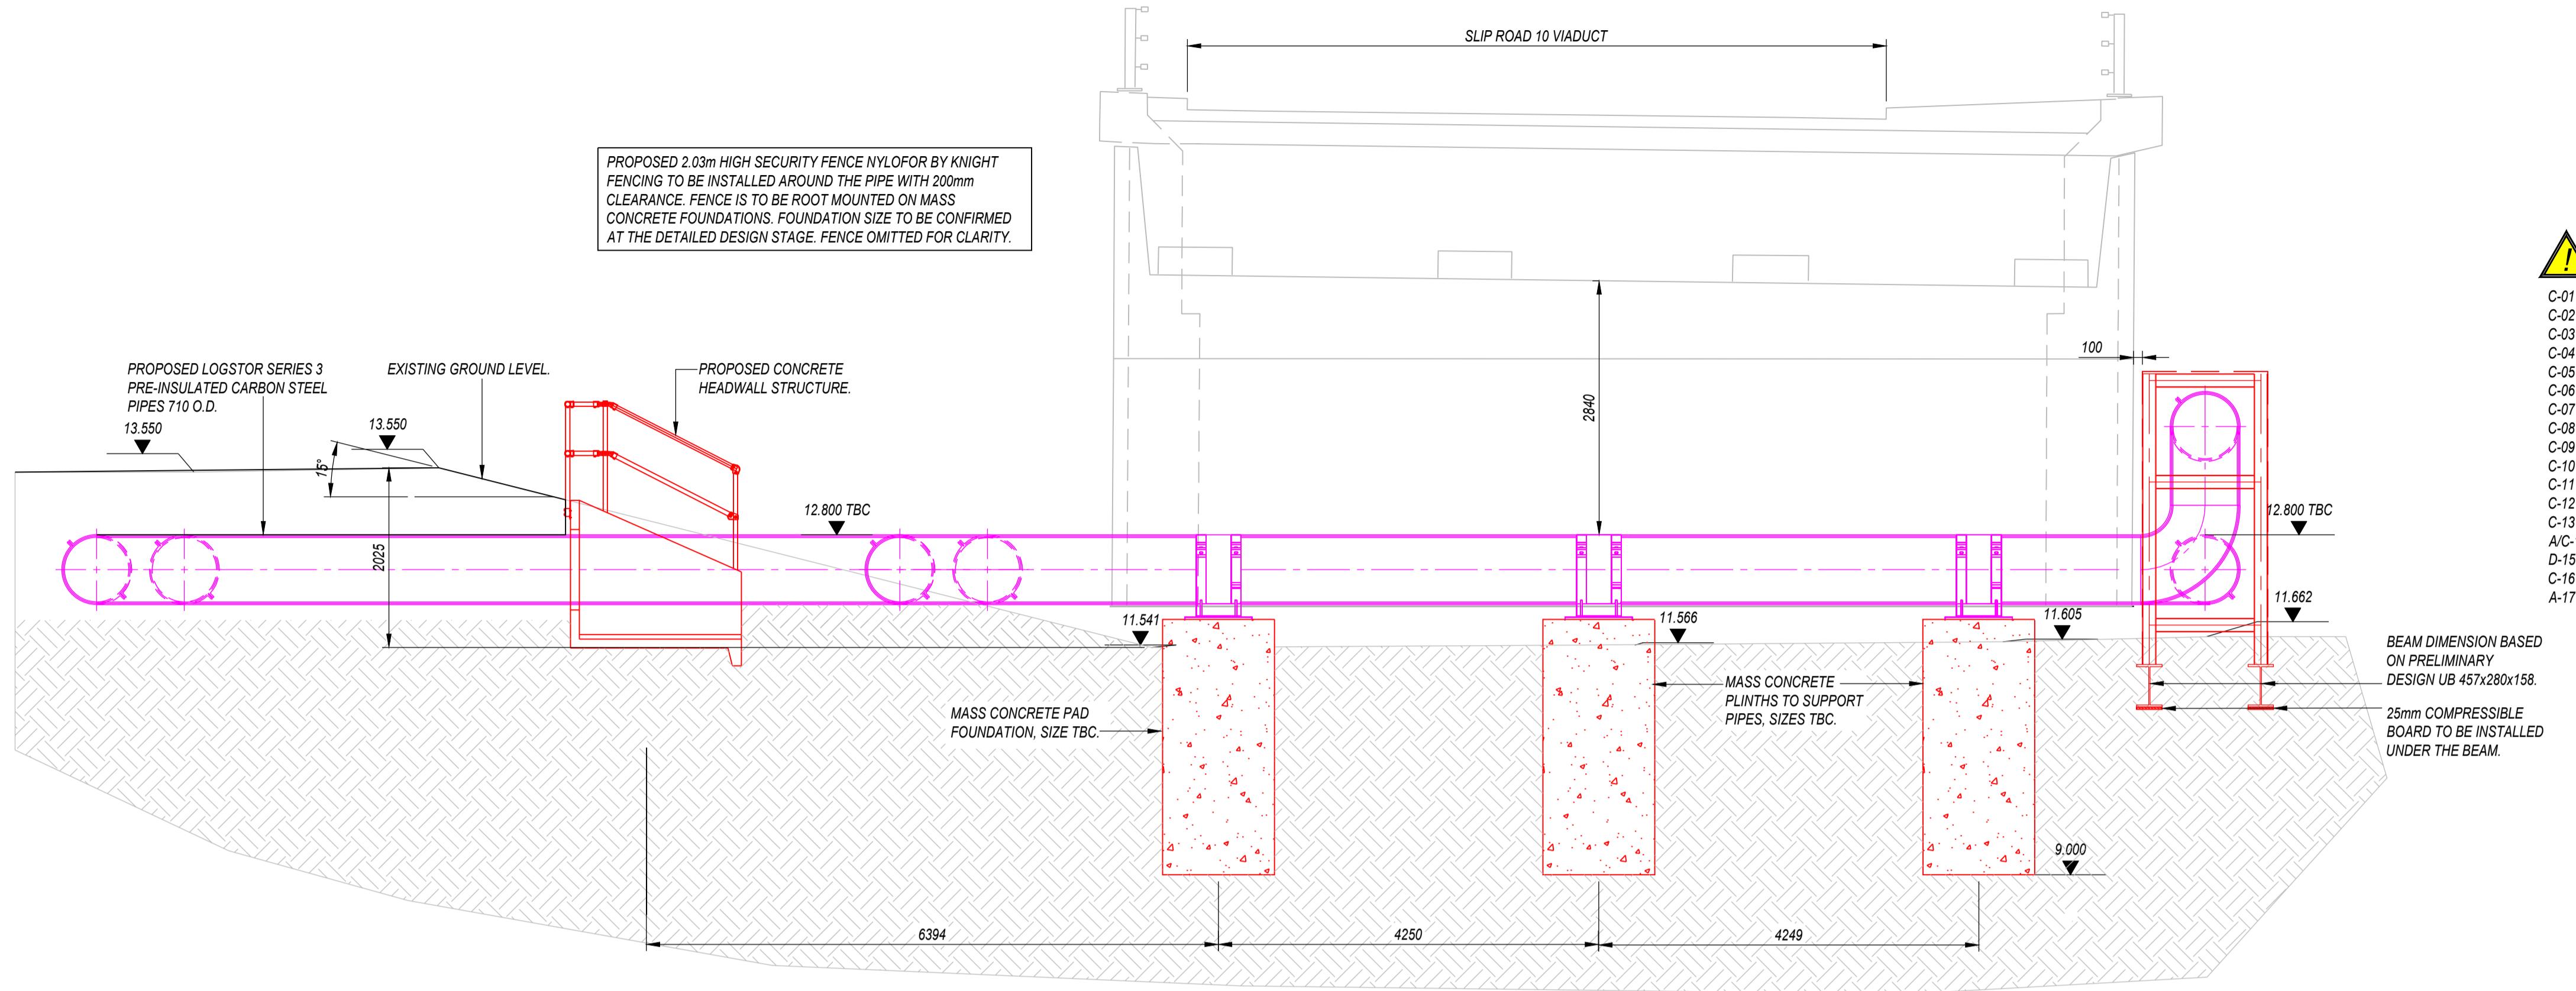

SECTION 4 - 4

SCALE 1:50

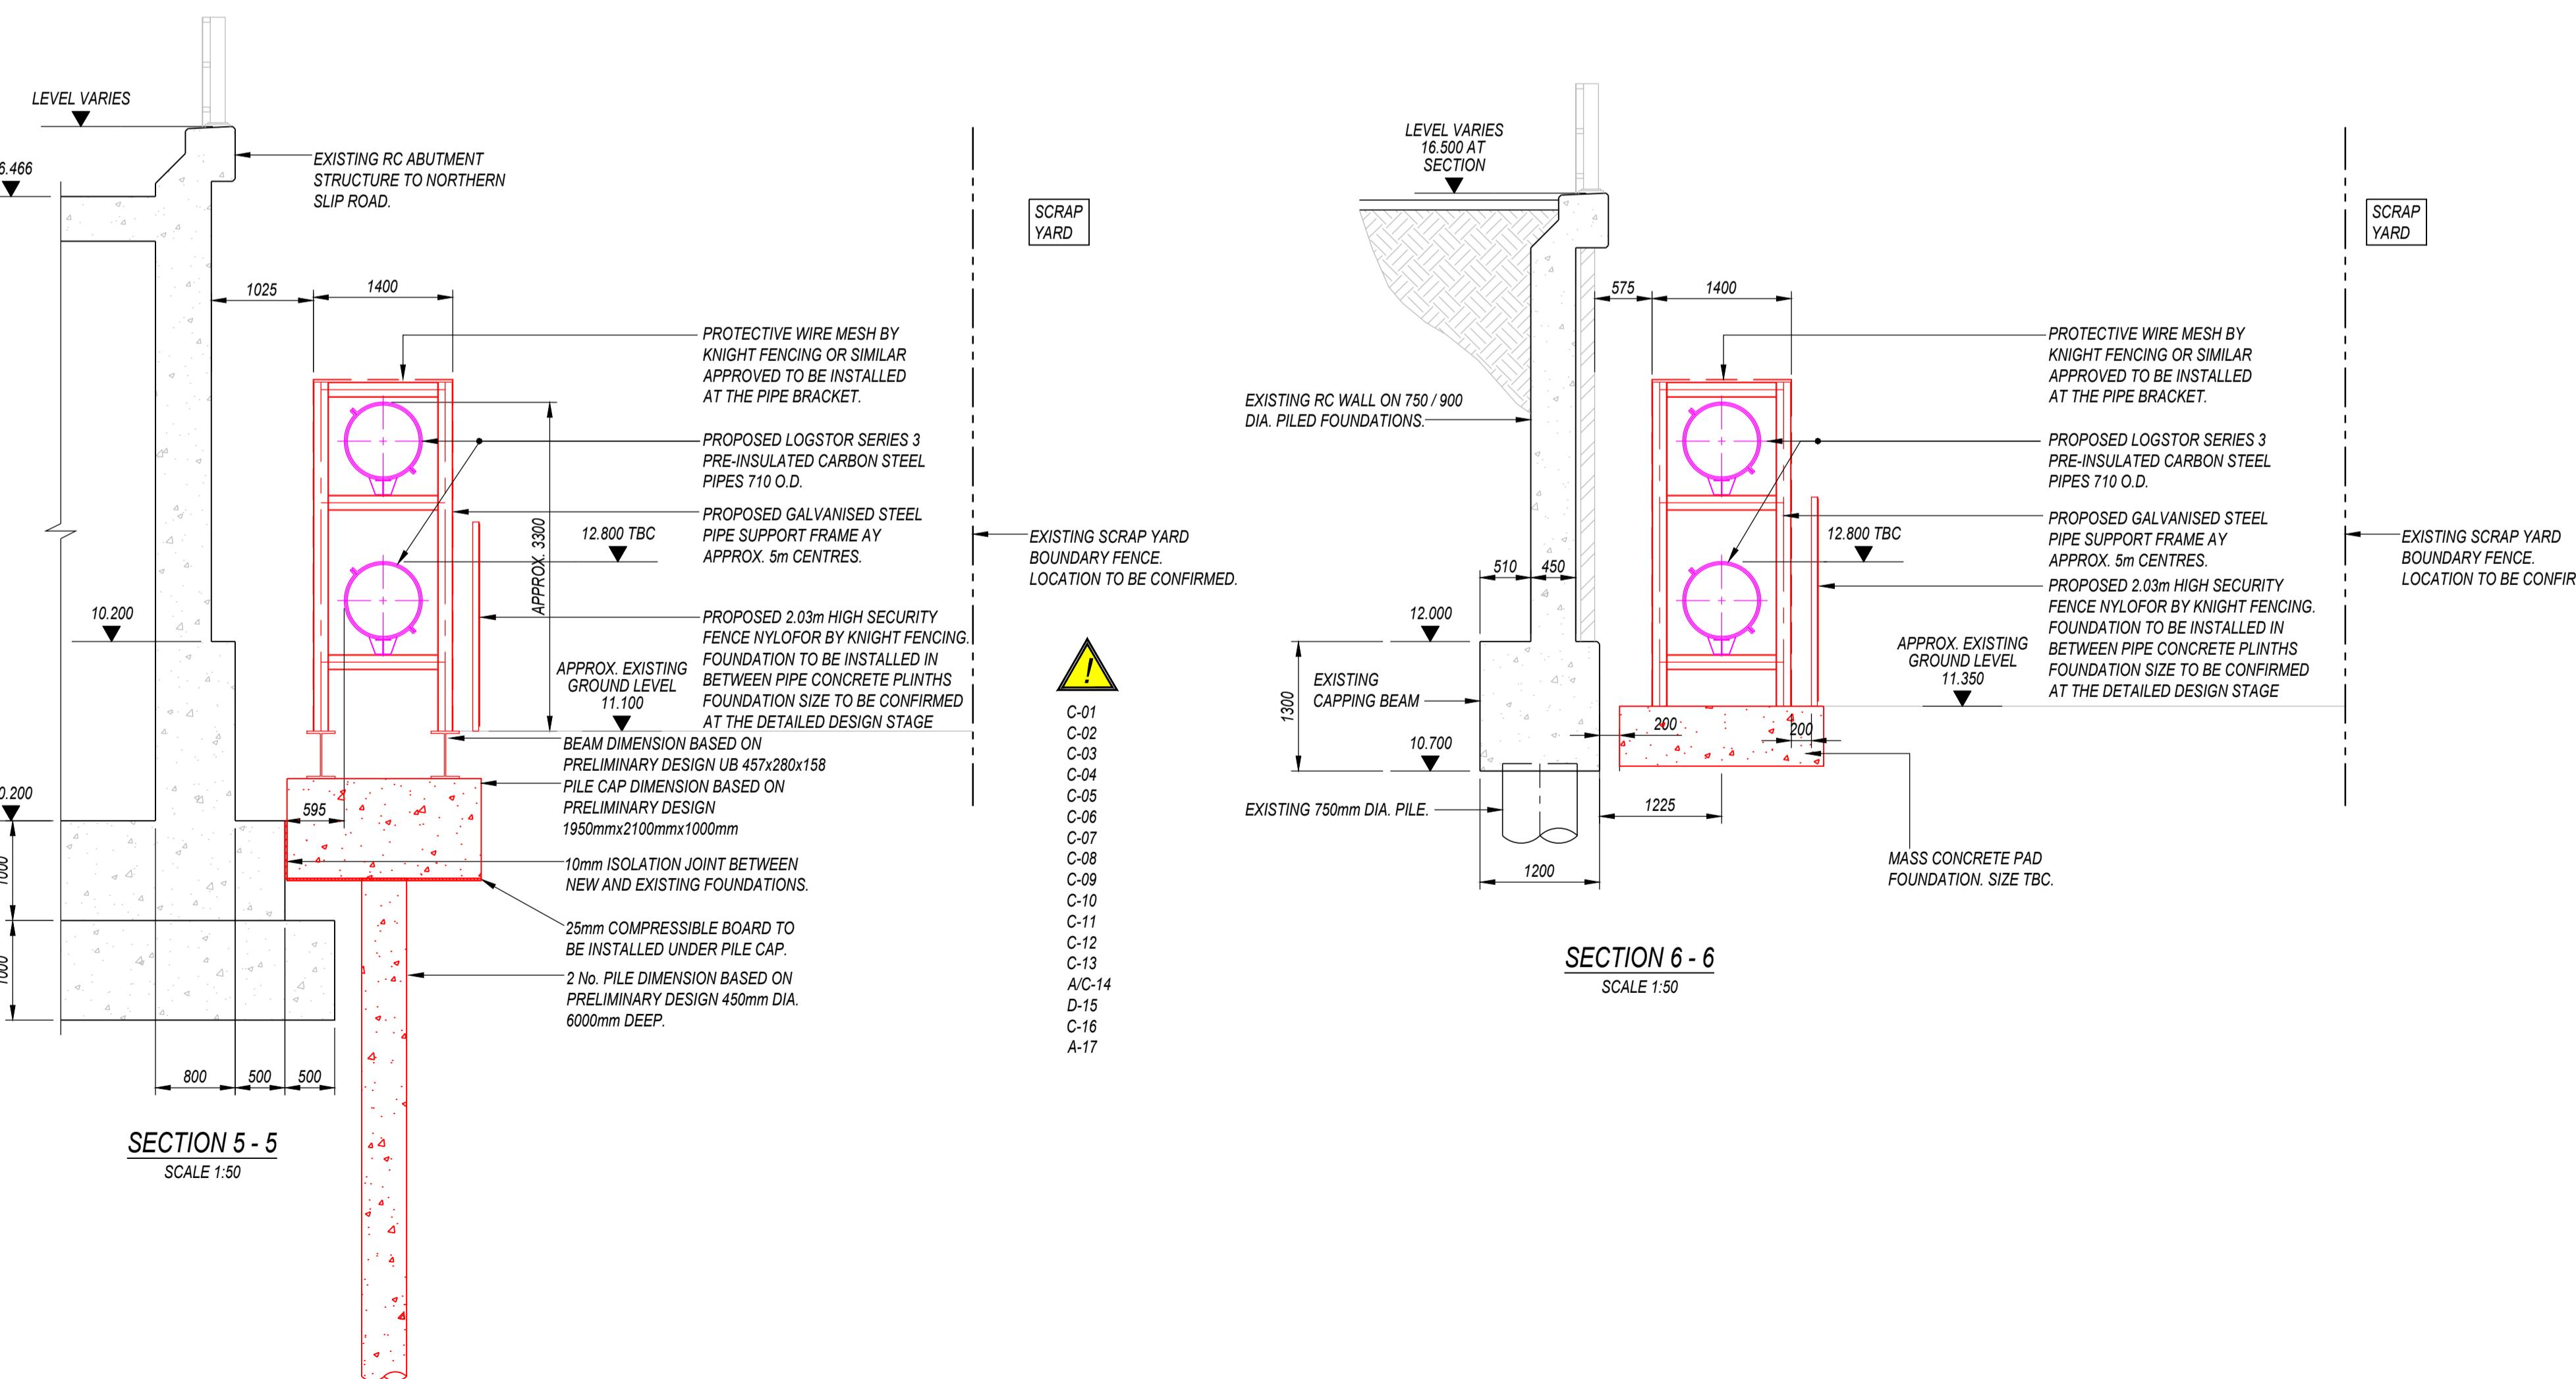

SECTION 6 - 6



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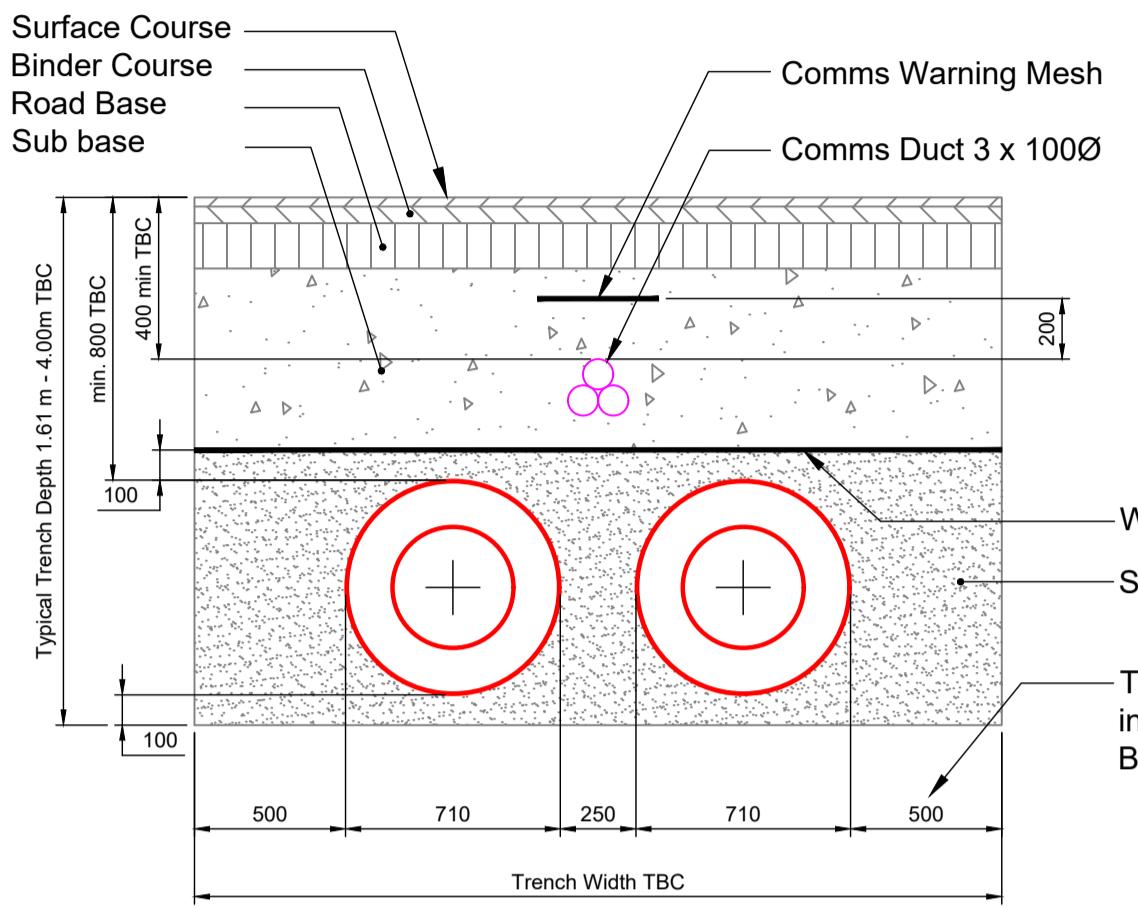
SECTION 5 - 5

SCALE 1:5


|  DRA KEY RESIDUAL RISK REGISTER | |
|---|---|
| C-01 | <u>WORKING ON OR NEAR ROAD / BRIDGE INFRASTRUCTURE.</u> SAFE ACCESS TO WORK AREA. |
| C-02 | <u>MANUAL HANDLING.</u> RISK OF PERSONNEL INJURIES. |
| C-03 | <u>WORKING ON 3rd PARTY LAND.</u> WORKING WITHOUT CONSENT. |
| C-04 | <u>EXCAVATIONS.</u> DAMAGE TO EXISTING ASSETS. |
| C-05 | <u>ENVIRONMENTAL HAZARDS.</u> DAMAGE TO ENVIRONMENT. |
| C-06 | <u>WORKING AT HEIGHT.</u> FALLING FROM HEIGHT. |
| C-07 | <u>STABILITY OF EXCAVATIONS.</u> SETTLEMENT OF GROUND FOLLOWING REINSTATEMENT OF MAINTENANCE ROAD. |
| C-08 | <u>HIGH WINDS.</u> RESTRICT LIFTING OPERATIONS DURING POSSESSION CAUSING POSSESSION OVERRUN. |
| C-09 | <u>UNIDENTIFIED INFRASTRUCTURE AND / OR BURIED SERVICES.</u> POTENTIAL DELAY IN WORKS. |
| C-10 | <u>ADJACENT STRUCTURES.</u> RISK OF DAMAGE TO ADJACENT STRUCTURES. |
| C-11 | <u>ADJACENT ROADS.</u> COLLISION WITH ROAD VEHICLES. |
| C-12 | <u>VEHICLE MOVEMENTS.</u> IMPACT ON SURROUNDING STREETS / RESIDENTIAL AREAS. |
| C-13 | <u>HABITATS.</u> LOSS OF HABITATS. |
| A/C-14 | <u>PROPRIETARY ELEMENTS / PRODUCT SPECIFICATION.</u> FAILURE OF THE PROPRIETARY ELEMENT / PRODUCT. |
| D-15 | <u>EXISTING ELEMENTS TO BE REMOVED.</u> CONTAMINATION / ACCESS CONSTRAINTS. |
| C-16 | <u>WORKING IN THE VICINITY OF EXISTING SERVICES.</u> DAMAGE TO THE BURIED SERVICES / INJURY TO OPERATOR. |
| A-17 | <u>PROPOSED FOUNDATIONS EITHER OVER OR ALONGSIDE EXISTING ASSETS.</u> OVERLOADING EXISTING ASSETS. |

FOR RESIDUAL RISKS IDENTIFIED ON THIS DRAWING, REFER TO
RESIDUAL RISK REGISTER 3605-VED-00-XX-DRA-CV-011001


| | | | | | |
|---|-----------------------------|--|--|--|--|
| NOTES | | | | | |
| THE ORIGINAL DRAWING IS IN COLOUR. | | | | | |
| ALL DIMENSIONS IN MILLIMETERS U.N.O. | | | | | |
| DO NOT SCALE FROM THIS DRAWING IN EITHER PAPER OR DIGITAL FORM. USE WRITTEN DIMENSIONS ONLY. | | | | | |
| DRAWING BASED ON - MURPHY GEOSPATIAL TOPOGRAPHICAL SURVEY DATED 31-05-23. | | | | | |
| ALL WORK TO BE CARRIED OUT IN ACCORDANCE WITH LOCAL AUTHORITY, STATUARY AUTHORITY AND HEALTH AND SAFETY REQUIREMENTS AND REGULATIONS REFER TO DESIGN RISK ASSESSMENT FOR RESIDUAL RISKS, INCLUSIVE OF SERVICES ADJACENT TO THE STRUCTURE. | | | | | |
| COLOUR KEY | | | | | |
| 31.61 | - | EXISTING LEVEL | | | |
| BLACK | - | EXISTING OR UNCHANGED | | | |
| GREEN | - | TO BE MODIFIED / REMOVED | | | |
| RED | - | NEW, PROPOSED OR ADDITIONAL | | | |
| PINK | - | BY OTHERS | | | |
| REV | DATE | BY | DESCRIPTION | | |
| 04 | 13.03.24 | SSS | ALIGNMENT REVISED FOLLOWING TFL COMMENTS | | |
| 03 | 15.12.23 | SS | FOR AIP REVIEW | | |
| 02 | 20.11.23 | SS | FOR AIP REVIEW | | |
| 01 | 08.09.23 | SS | FOR AIP REVIEW | | |
| 01 | 21.07.23 | SS | FOR INFORMATION | | |
| REV | DATE | BY | DESCRIPTION | | |
|  | | London Office Highland House, 165 The Broadway, Wimbledon, London, SW11 3BY T: +44 (0)20 3214 5217 E: info@veda.co.uk www.veda.co.uk | | | |
| CLIENT | | | | | |
|  PROVEN PROJECT CONSTRUCTION District Heating | | | | | |
| PROJECT TITLE | | | | | |
| MERIDIAN WATER A406 CROSSING | | | | | |
| DRAWING TITLE | | | | | |
| PROPOSED SECTIONS | | | | | |
| SHEET 1 | | | | | |
| DRAWING STATUS | | | | | |
| FOR AIP REVIEW | | | | | |
| DRAWING No. | 3605-VED-00-XXDWG-CV-013002 | | REV A04 | | |
| DATE | JULY 2023 | | SCALE @ A1 AS SHOWN | | |
| DRAWN | SS | CHECKED CPL | VEDA JOB No. 3605 | | |

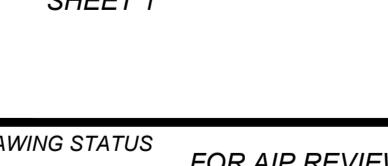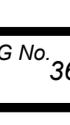


DN400/710OD SERIES 3
TYPICAL TRENCH DETAIL

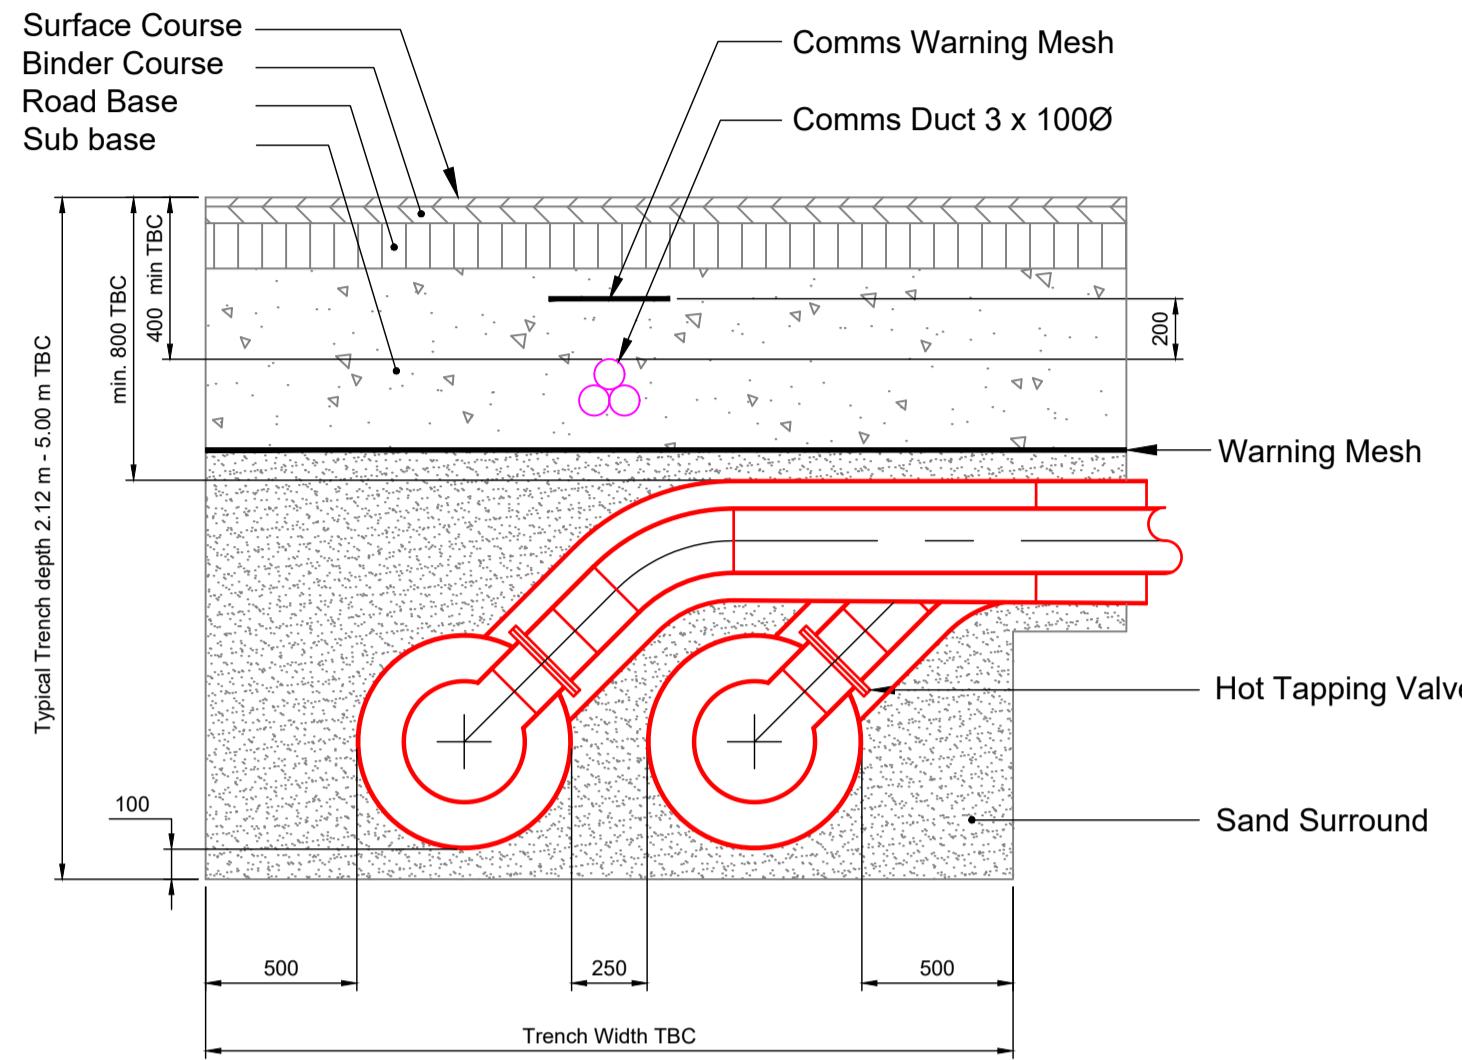


DN400/710OD SERIES 3
TYPICAL TRENCH DETAIL C/W 45° HOT TAPPING

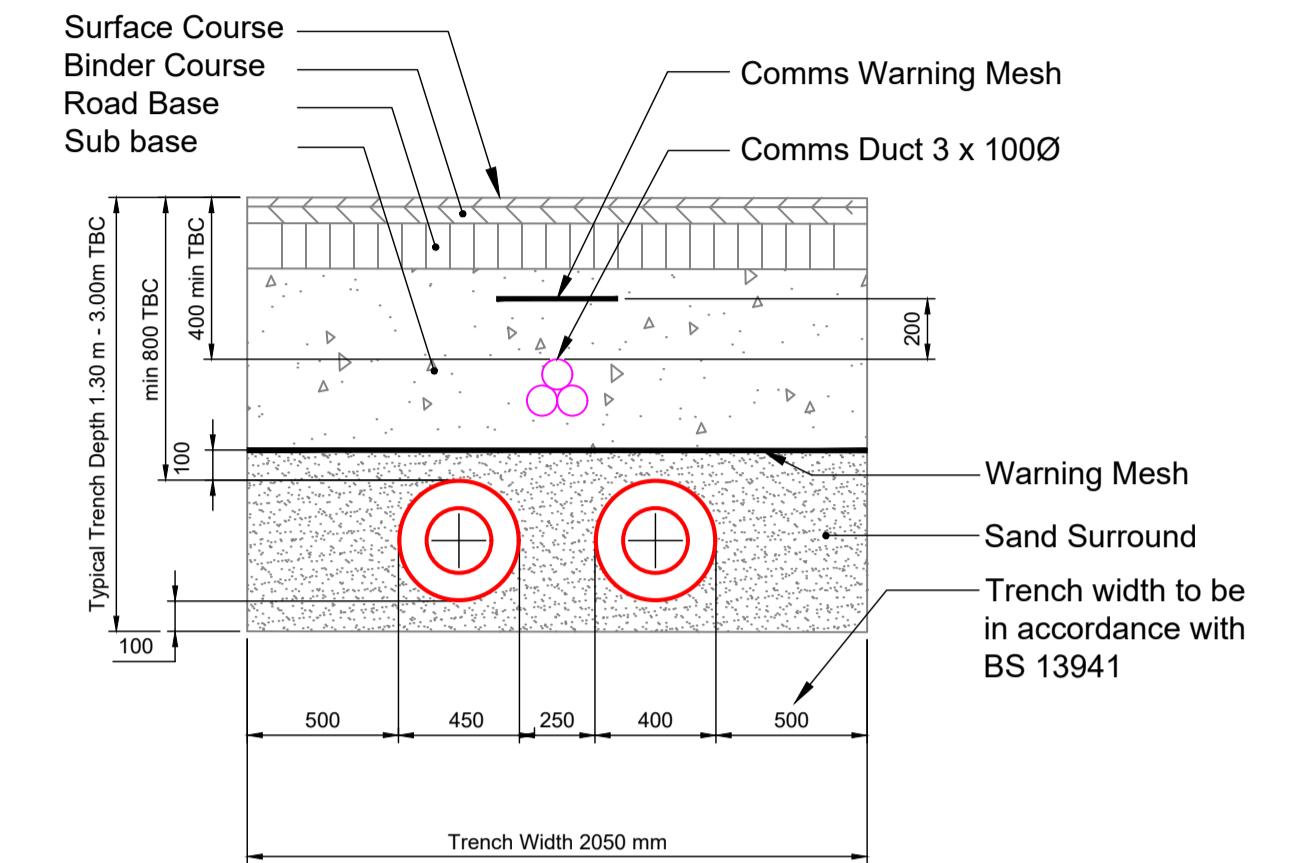


DN200/400OD SERIES 3
TYPICAL TRENCH DETAIL

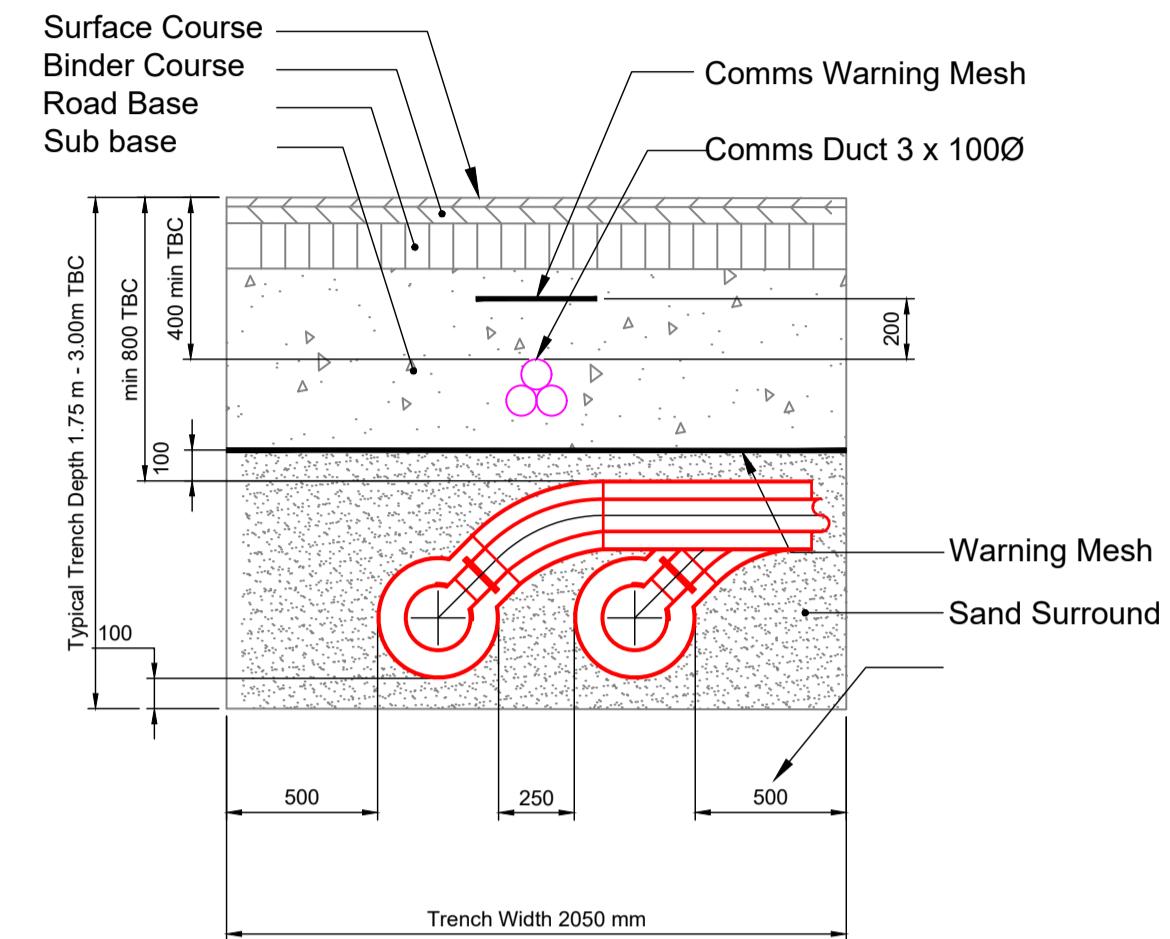


DN200/400OD SERIES 3
TYPICAL TRENCH DETAIL C/W 45° HOT TAPPING

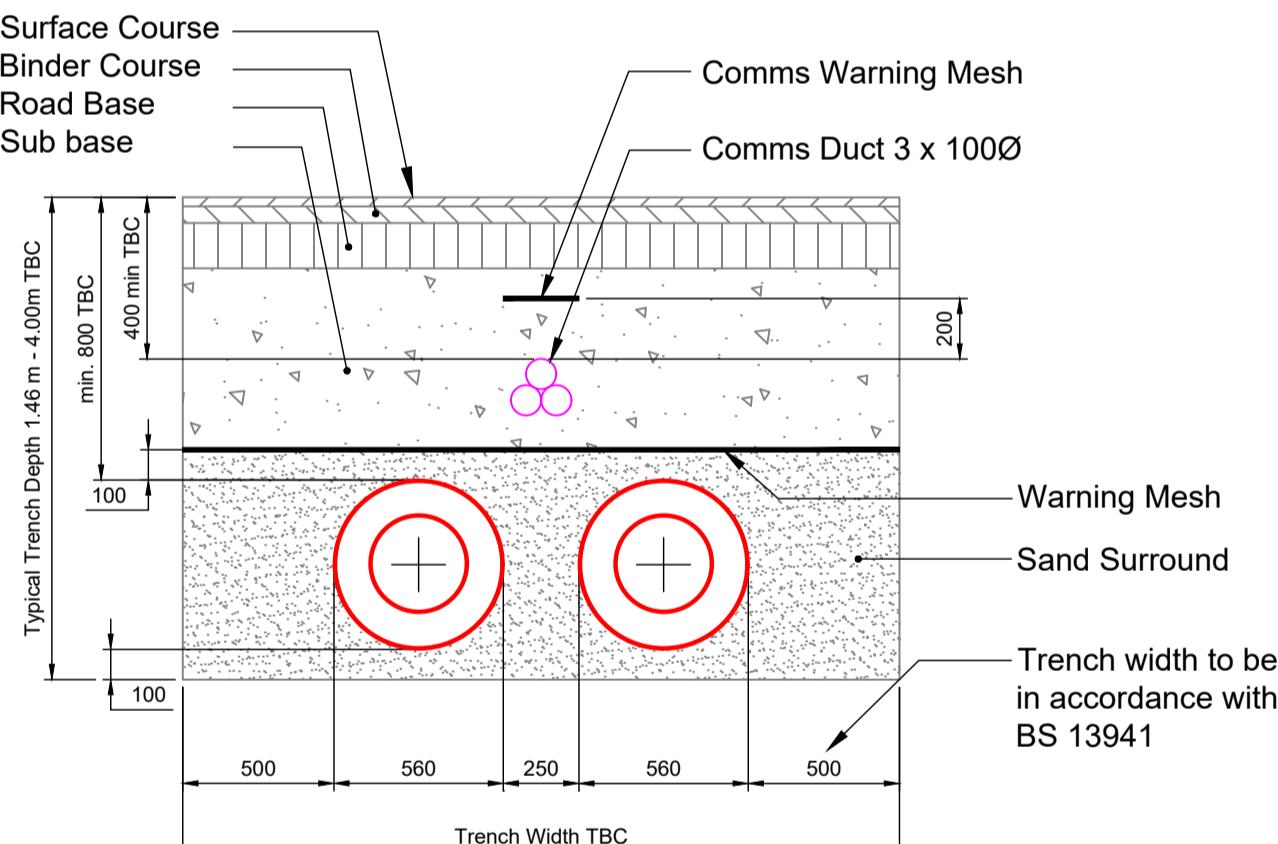

DN300/560OD SERIES 3
TYPICAL TRENCH DETAIL

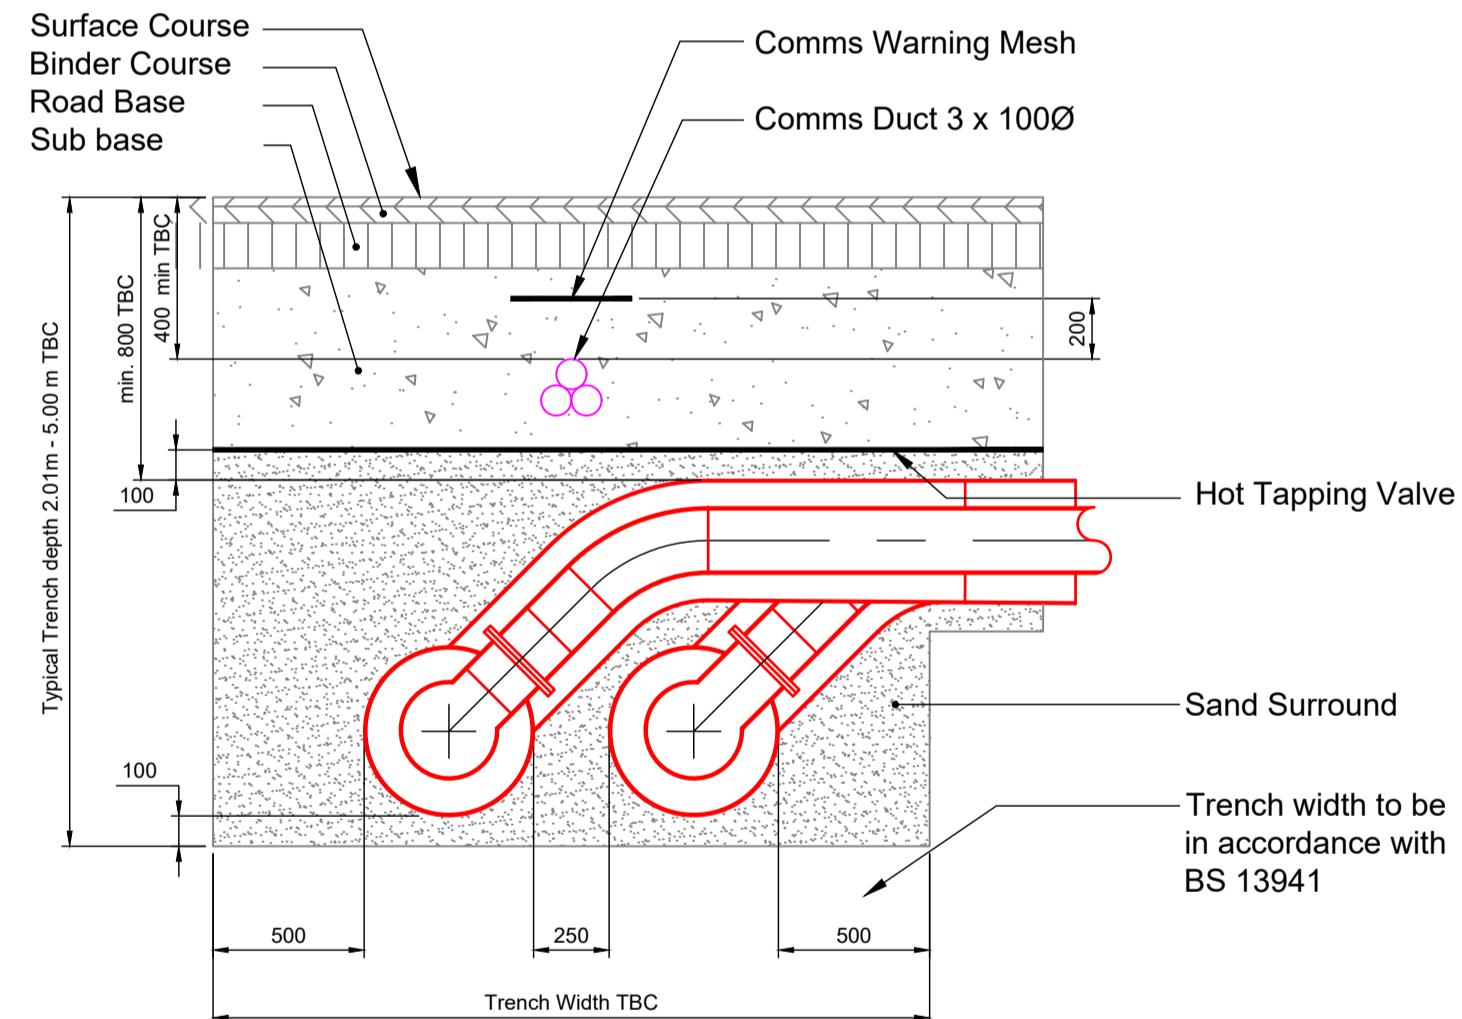

DN300/560OD SERIES 3
TYPICAL TRENCH DETAIL C/W 45° HOT TAPPING

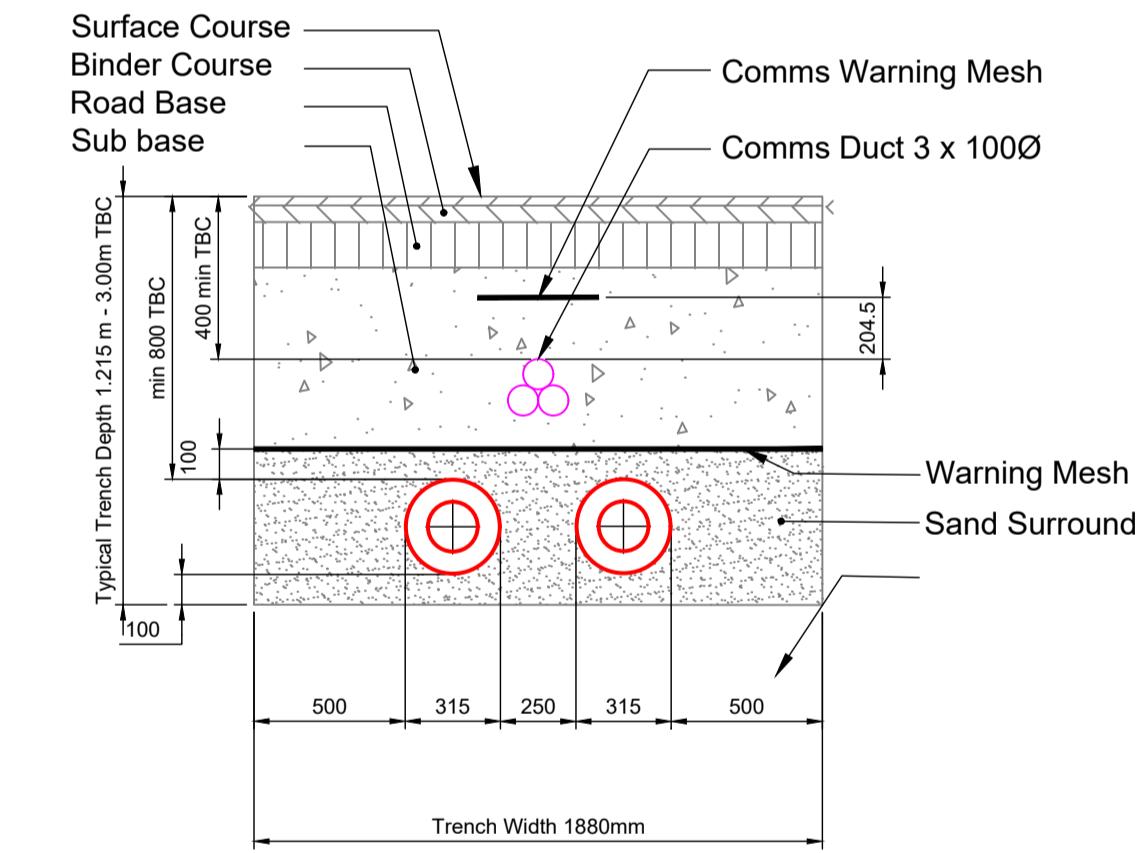

DN150/315OD SERIES 3
TYPICAL TRENCH DETAIL

NOTES:

For additional technical information please refer to the Logstar manuals

1. Design
2. Design with Twin Pipes
3. Product Catalogue
4. Surveillance
5. Handling & Installation